APPLICABLE CODES					
ZONING CODE	CITY OF MADISON ZONING CODE				
BUILDING CODE	WISCONSIN SPS 362 / 2015 IBC				
EXISTING BUILDING CODE	WISCONSIN SPS 366 / 2015 IEBC				
ACCESSIBILITY CODE	2009 ICC A117.1				
FIRE SAFETY CODE	WISCONSIN SPS 314 / 2012 NFPA 1				
PLUMBING CODE	WISCONSIN SPS 381-387				
ELECTRICAL CODE	WISCONSIN SPS 316 / 2017 NEC / 2017 NFPA 70				
MECHANICAL CODE	WISCONSIN SPS 364 / 2015 IMC				
ENERGY CODE	WISCONSIN SPS 363 / 2015 IECC				
ZONING					
CLASSIFICATION	PR PARKS AND RECREATION				
PERMITTED USE	CONDITIONAL USE AS A COMMUNITY CENTER				
MINIMUM LOT SIZE	5 ACRES				
MAXIMUM HEIGHT	2 STORIES / 35' (MAXIMUM HEIGHT MAY BE EXCEEDED WITH CUP APPROVAL)				
SETBACKS REQUIRED					
FRONT YARD	30'				
SIDE YARD	30'				
REAR YARD	30'				
PARKING					
# OF SPACES REQ'D	STAFF TO PROVIDE DETERMINATION IN PR DISTRICT, DEPENDING UPON USE PROPOSED				
# OF SPACES PROVIDED	78				
NOTES					

EXISTING OCCUPANCY, OCCUPANT LOAD, AND MEANS OF EGRESS TO REMAIN UNLESS NOTED OTHERWISE.

GRADE PLANE PER IBC CHAPTER 2 = EL 105'-0"

DISCREPANCIES SHALL BE REPORTED TO THE ARCHITECT.

ADJAÇENT BUILDINGS. SEE BOUNDARY, TOPOGRAPHIC, AND UTILITY SURVEY FOR ADDITIONAL INFORMATION.

BUILDING PERIMETER IS GREATER THAN 30' FROM CLOSEST INTERIOR LOT LINE, ENTIRE WIDTH OF NEAREST PUBLIC WAY, AND ANY

GENERAL NOTE REGARDING EXISTING CONDITIONS: EXISTING BUILDING PLANS HAVE BEEN SHOWN ACCORDING TO ORIGINAL BUILDING PLANS AND SOME FIELD MEASUREMENTS. EXISTING CONDITIONS AND DIMENSIONS SHALL BE FIELD VERIFIED BY CONTRACTORS AND ANY

GENERAL NOTE REGARDING SCOPE IN EXISTING BUILDING: FACILITY WILL REMAIN OPERATIONAL DURING CONSTRUCTION. CONTRACTOR SHALL COORDINATE DAILY WORKING AREAS WITH BUILDING OWNER AND PROVIDE AT LEAST (4) WEEKS' NOTICE IF ANY SPACES IN THE

DATE OF ORIGINAL CONSTRUCTION	1998			
OCC. CLASSIFICATION	A-3 (COMMUNI	TY HALL), B AC	CESSORY (EXISTING)	
CONSTRUCTION TYPE	IIB (EXISTING)			
ALTERATION TYPE	ADDITION + LE	VEL 2 ALTERAT	ION	
SPRINKLERED	YES - NFPA 13			
FIRE ALARM	YES - COMPLIA	ANT WITH IBC 90	7.5.2.2	
BUILDING HEIGHT (NEW CONSTRUCTION)	25'-3" ABOVE G	RADE PLANE		
NUMBER OF STORIES	1 (EXISTING M	EZZANINES)		
SQUARE FEET/ FLOOR	ALLOWABLE			ACTUAL
FIRST FLOOR	38,000 SF + 9,500 SF = 47,500 SF 42,940 SF			42,940 SF
	100% FRONTA	GE INCREASE		
<b>CONSTRUCTION RI</b>	EQUIREI	MENTS		
EXT. WALLS-NON BEARING	0 - HR			
STRUCTURAL FRAME	0 - HR			
PARTITIONS	0 - HR			
SHAFT ENCLOSURES	1 - HR LESS TH	IAN FOUR STOF	RIES	
FLOOR/CEILING	0 - HR			
ROOF/CEILING	0 - HR			
ROOFING CLASSIFICATION	CLASS C			
ENERGY				
CLIMATE ZONE	6			
ENVELOPE REQUIREMENTS	R-VALUE		U-FACTOR	PROVIDED
ROOF	20		0.048	R-35
WALLS	13.3		0.080	R-20
BELOW GRADE	7.5		0.119 (C-VALUE)	R-20
UNHEATED SLAB-ON-GRADE	10 @ 24" BELO	W	0.54 (F-VALUE)	R-20 @ 48" BELOW
DOORS			0.70	U-0.70
FENESTRATION REQUIREMENTS	SHGC	SHGC	U-FACTOR	PROVIDED

OCCUPANT LOAD		1657 OCCUPANTS							
EXITS PER STORY REQ'D		4	4						
EXITS PER STORY PROVIDED		5							
EXIT DOOR WIDTH REQ'D		249"							
EXIT DOOR WIDTH PROVIDED		366"							
EXIT ACCESS TRAVEL DISTAN	CE REQ'D	250'							
EXIT ACCESS TRAVEL DISTAN	CE PROVIDED	SEE CODE CONF	ORMANCE PLAN						
PLUMBING									
IEBC 810.1 / IBC TABLE 2902.1									
FIXTURES	OCCUPAN <sup>-</sup>	ΓLOAD	REQUIREMENTS	REQUIRED	PROVIDE				
WATER CLOSETS	MEN	829	1 PER 125 OCCUPANTS	7	8				
WATER CLOSETS	WOMEN	829	1 PER 65 OCCUPANTS	13	9 + 4 UNISEX				
				20	21				
LAVATORIEC	MEN	829	1 PER 200 OCCUPANTS	5	5				
LAVATORIES	WOMEN	829	1 PER 200 OCCUPANTS	5	5 + 4 UNISEX				
				10	14				
DRINKING FOUNTAINS	1657		1 PER 500 OCCUPANTS	4	5				
SERVICE SINKS				1	2				



MILWAUKEE | MADISON | CHICAGO

# WARNER PARK COMMUNITY RECREATION CENTER EXPANSION

223471.00

DATE

6/13/2024

1625 NORTHPORT DRIVE MADISON, WI 53704 CITY OF MADISON PARKS DIVISION 330 EAST LAKESIDE STREET

PROJECT NUMBER

NO. DESCRIPTION

1 ADDENDUM #2


MADISON, WI 53715


ISSUED FOR:	
BID SET	5/16/2024
REVISION FOR:	

DRAWN BY	DKB
CHECKED BY	JWH

CODE CONFORMANCE

G001

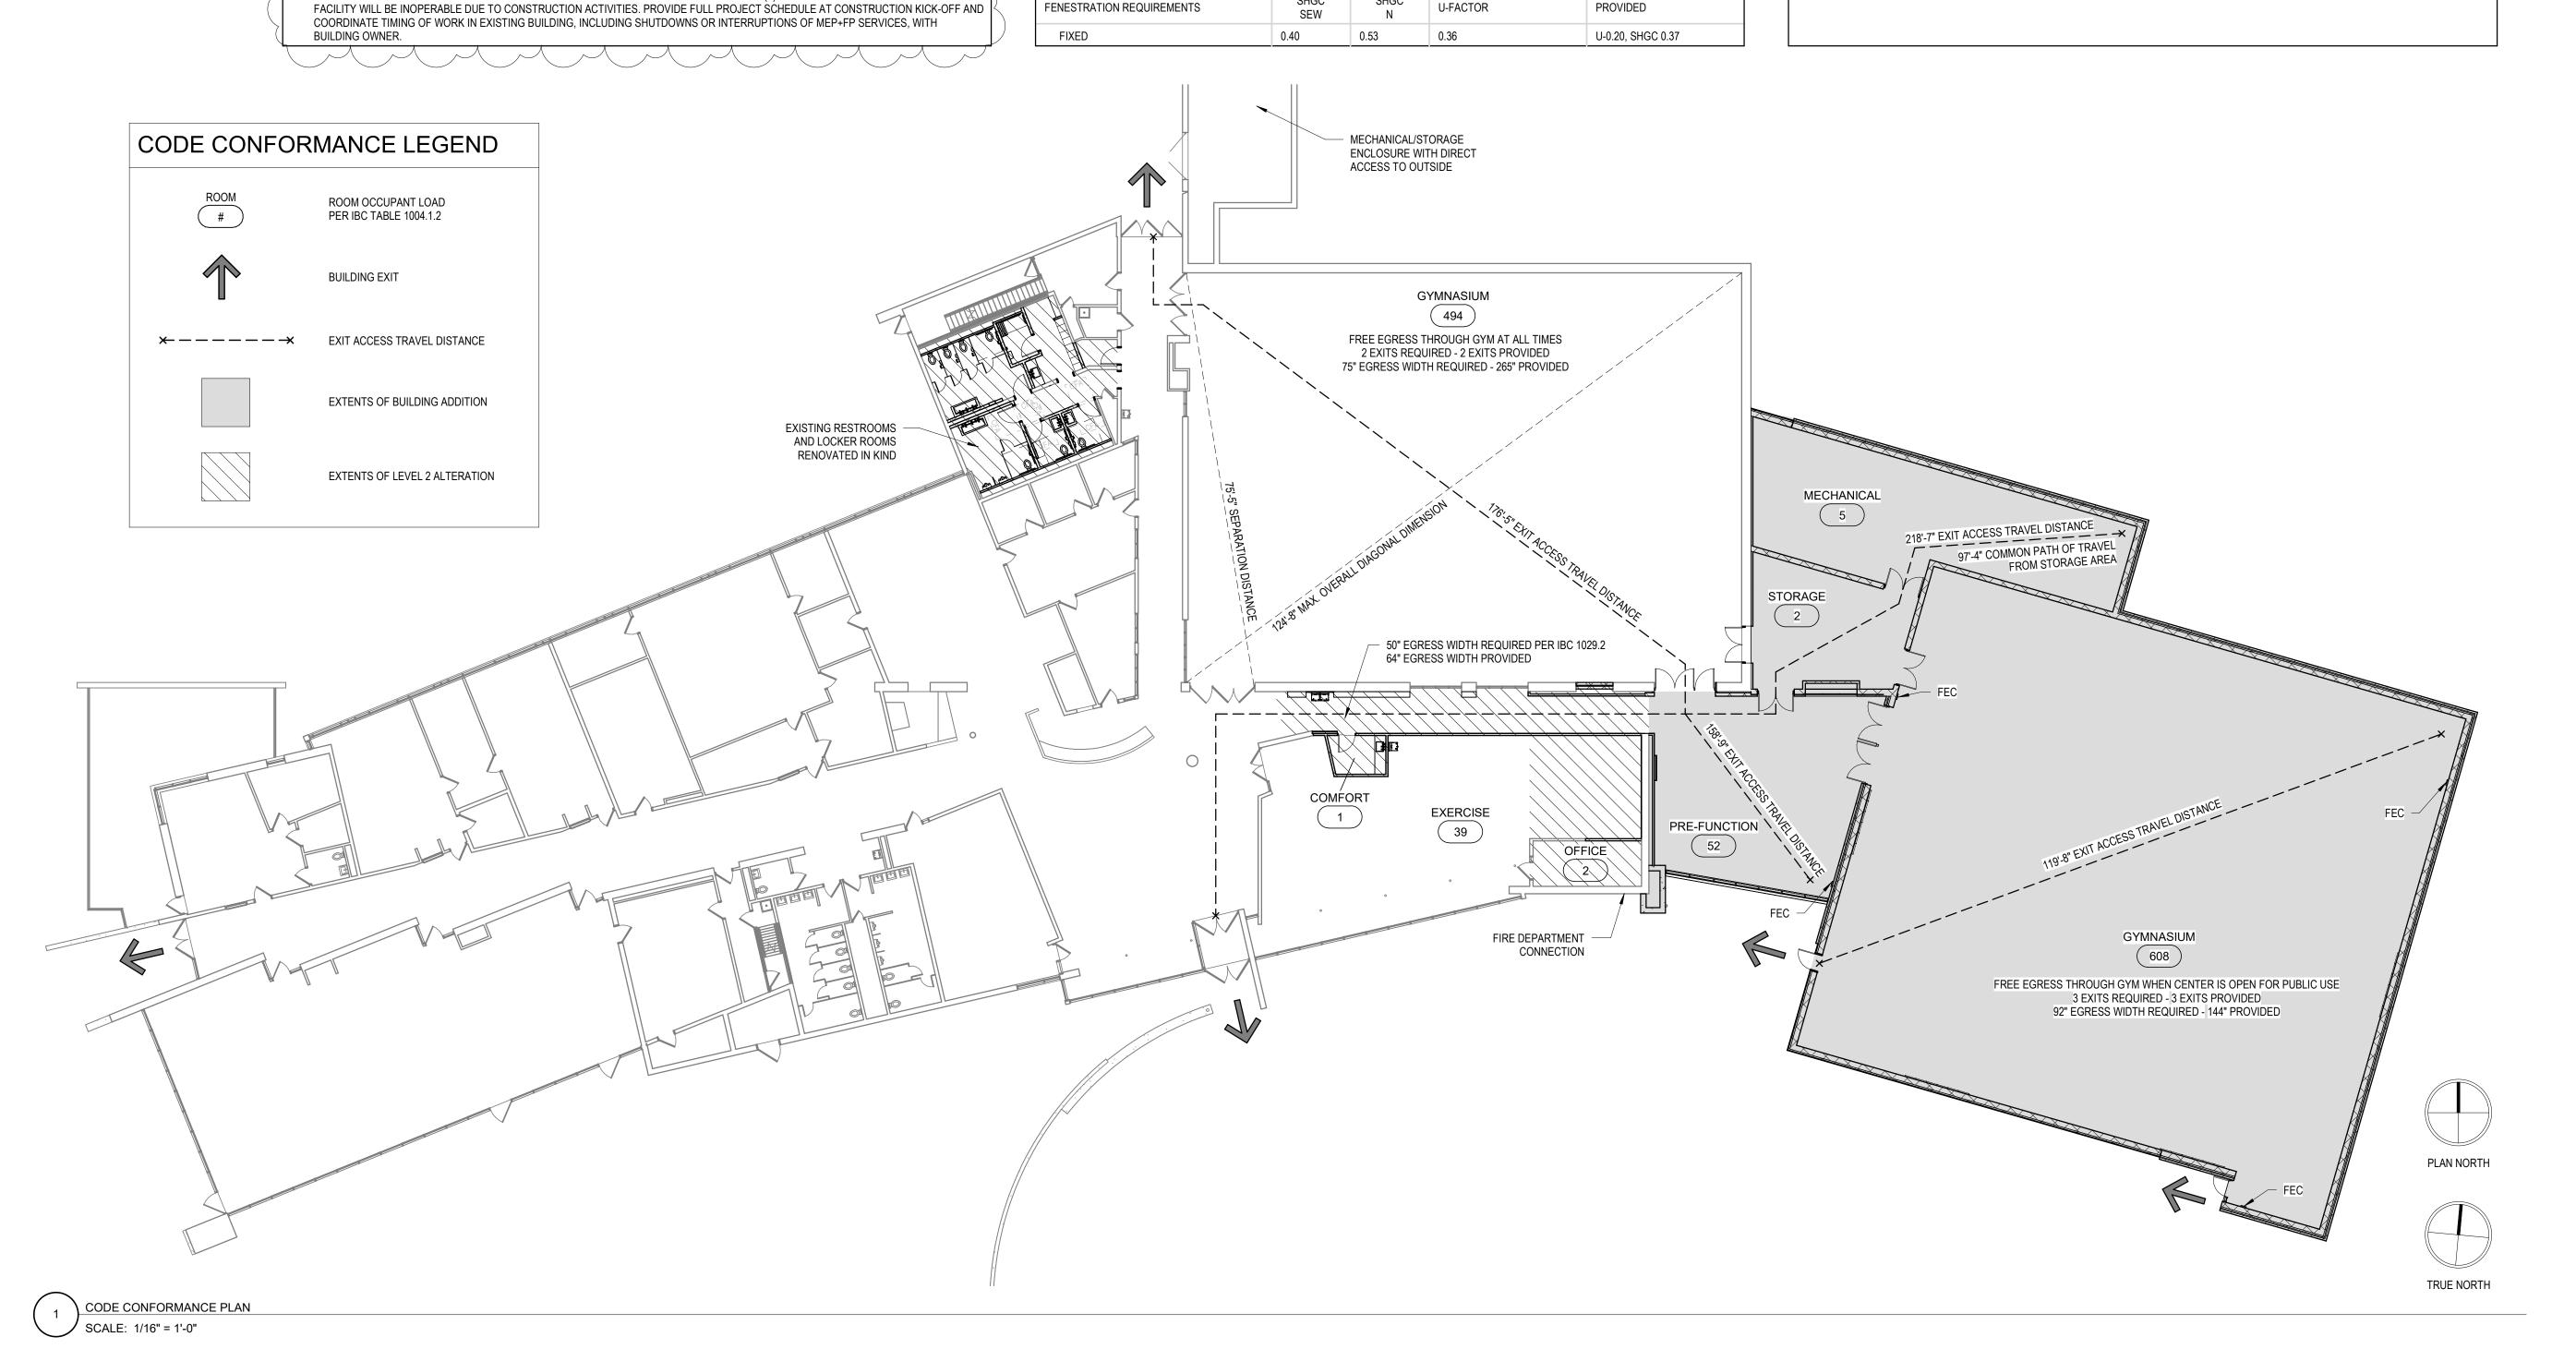

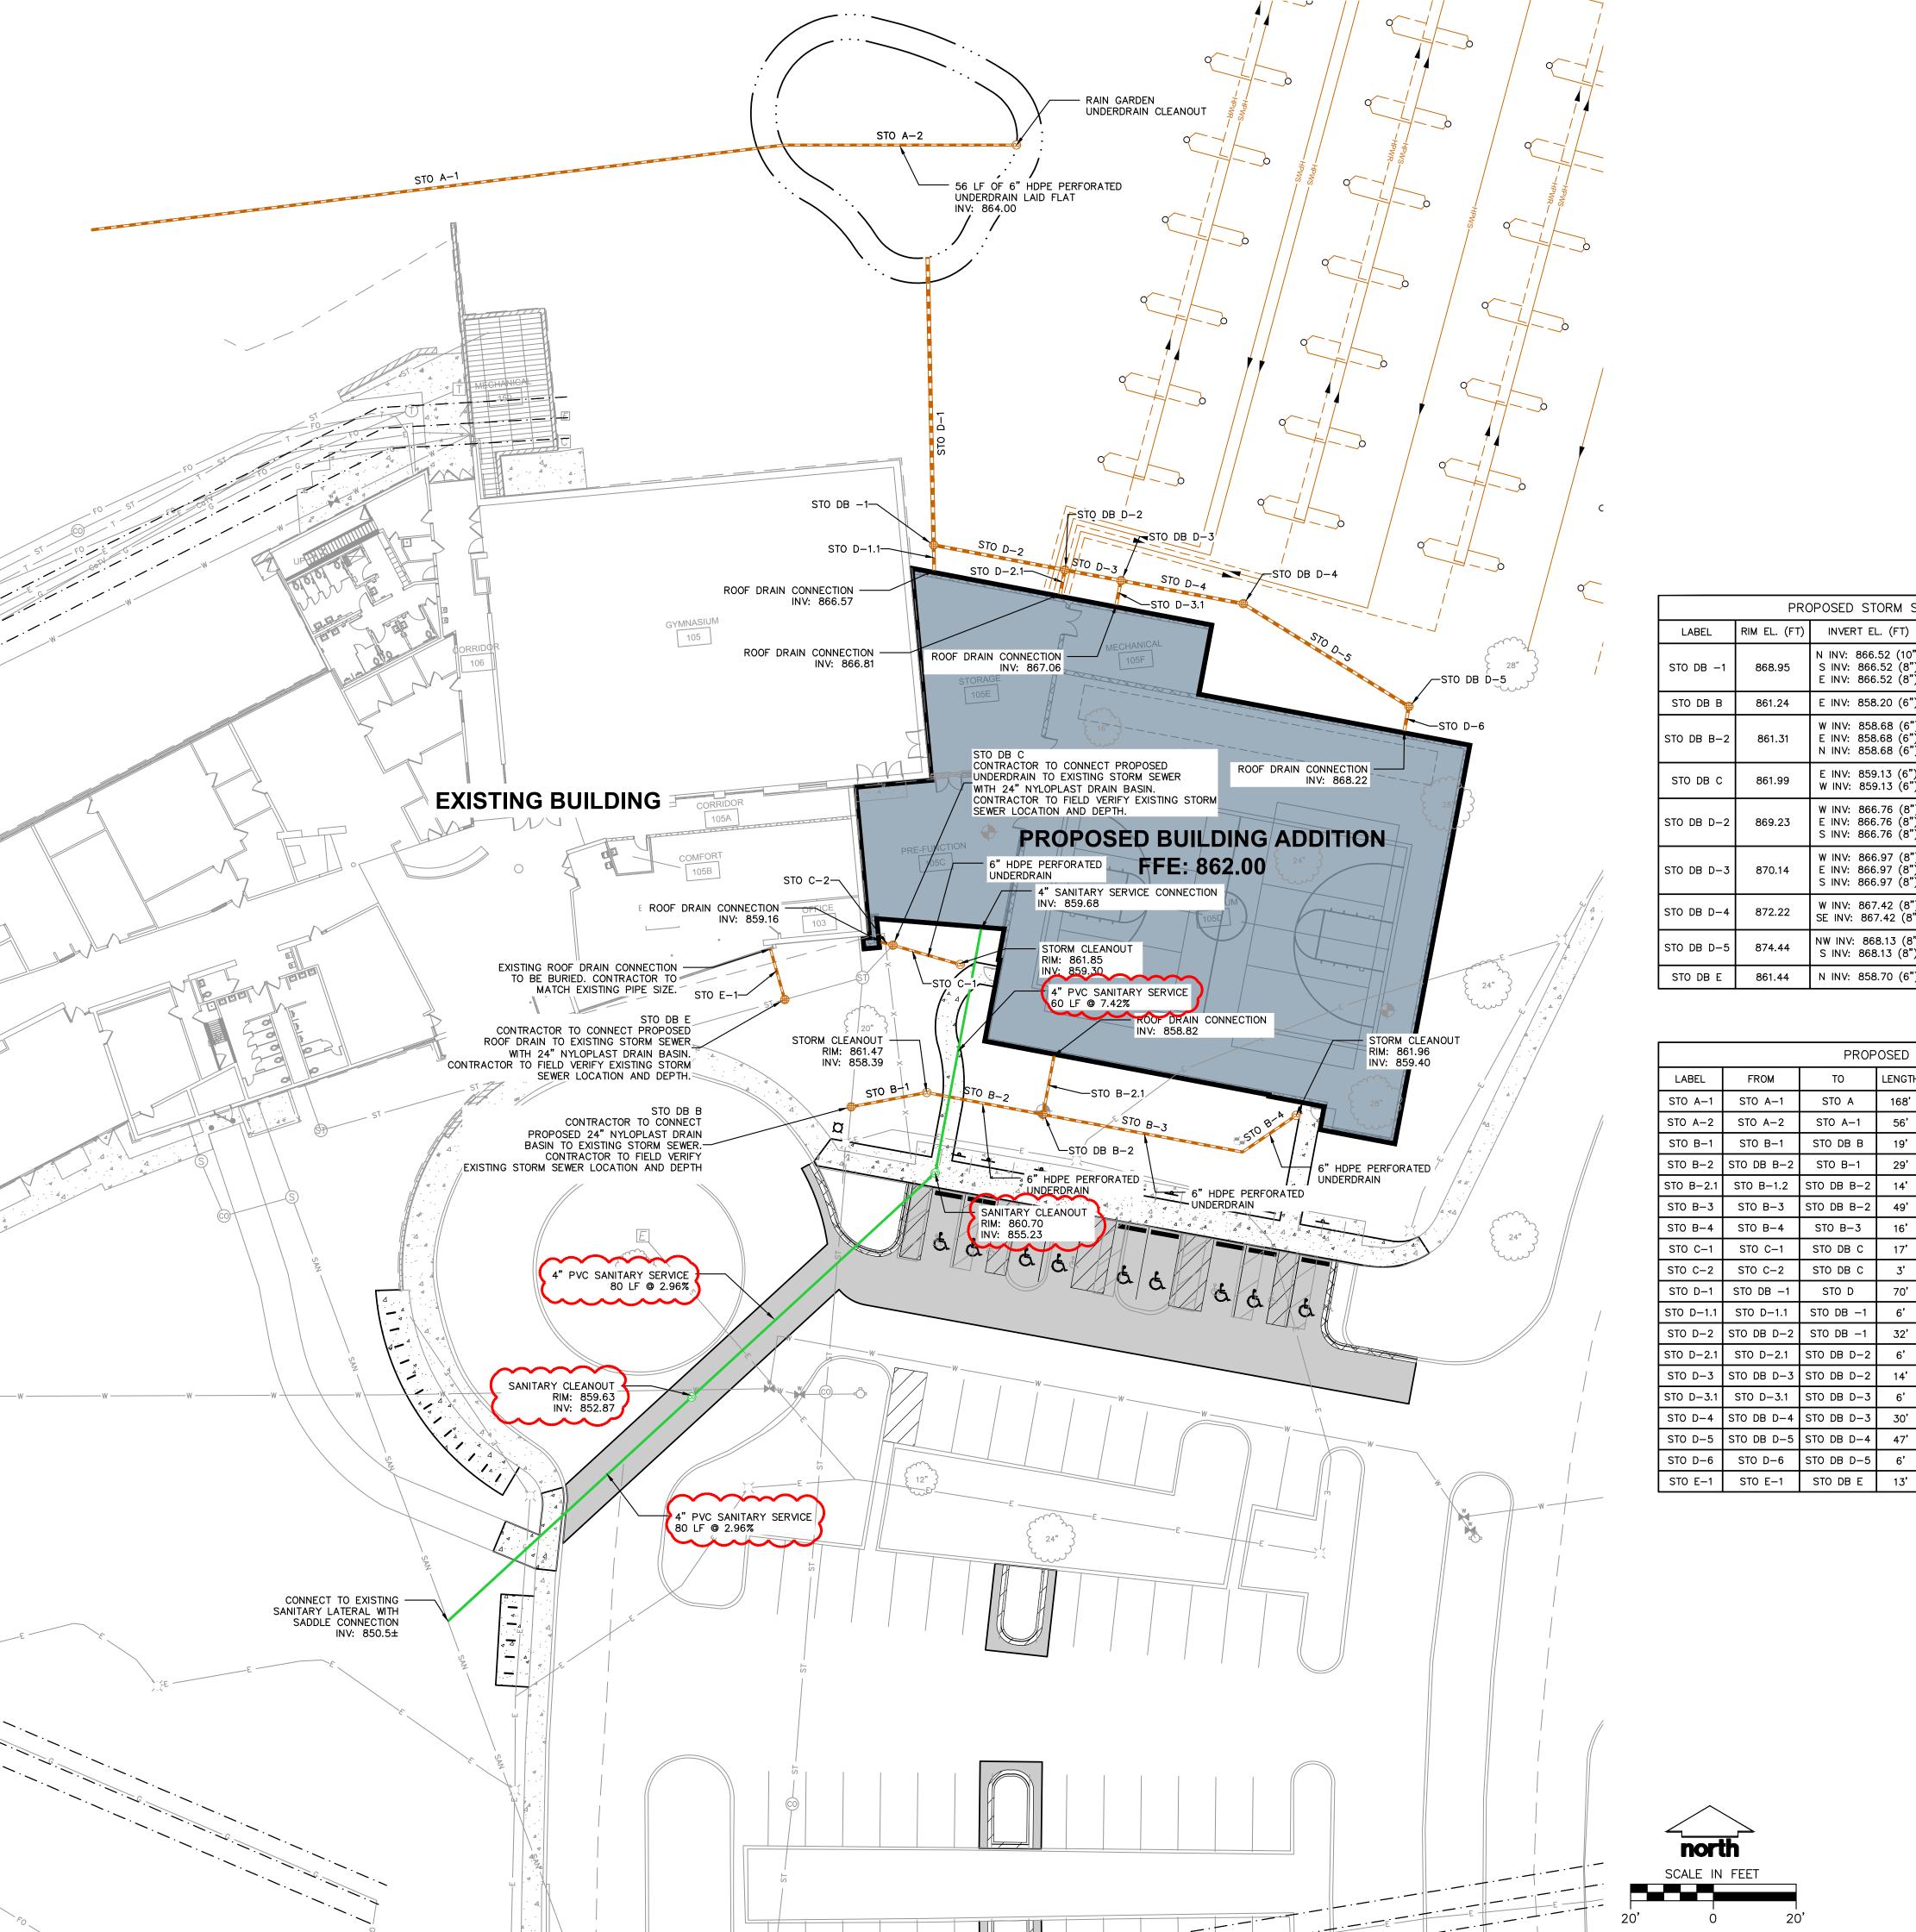





# WARNER PARK COMMUNITY RECREATION CENTER **EXPANSION**

1625 NORTHPORT DRIVE MADISON, WI 53704

CITY OF MADISON PARKS DIVISION CITY-COUNTY BUILDING, ROOM 104

210 MARTIN LUTHER KING JR. BLVD MADISON, WI 53703

PROJECT NUMBER

ISSUED FOR:

223471.00

05/16/2024

6/13/2024

CHG/MRA

KJY

**REVISION FOR:** 

BID SET

ADDENDUM 2

6'	864.00	864.00	0.00%	6 IN HDPE	
9'	858.39	858.20	1.00%	6 IN HDPE	
9'	858.68	858.39	1.00%	6 IN HDPE	
4'	858.82	858.68	1.00%	6 IN HDPE	
9'	859.17	858.68	1.00%	6 IN HDPE	
6'	859.40	859.17	1.50%	6 IN HDPE	
7'	859.30	859.13	1.00%	6 IN HDPE	
3'	859.16	859.13	1.00%	6 IN HDPE	
0'	866.52	866.00	0.75%	10 IN HDPE	
3'	866.57	866.52	0.75%	8 IN HDPE	
2'	866.76	866.52	0.75%	8 IN HDPE	
s'	866.81	866.76	0.75%	8 IN HDPE	
4'	866.97	866.76	1.50%	8 IN HDPE	
s'	867.06	866.97	1.50%	8 IN HDPE	
0'	867.42	866.97	1.50%	8 IN HDPE	DRAWN BY
7'	868.13	867.42	1.50%	8 IN HDPE	DIO WIN DI
s'	868.22	868.13	1.50%	8 IN HDPE	CHECKED BY
3'	858.95	858.70	2.00%	6 IN HDPE	525.KEB B1

FRAME & GRATE

ADS DRAIN WITH BEEHIVE GRATE

ADS DRAIN WITH

BEEHIVE GRATE

ADS DRAIN WITH BEEHIVE GRATE

ADS DRAIN WITH

BEEHIVE GRATE

ADS DRAIN WITH BEEHIVE GRATE

ADS DRAIN WITH BEEHIVE GRATE

1.19% 6 IN HDPE

PROPOSED STORM SEWER STRUCTURE TABLE

N INV: 866.52 (10<sup>3</sup>

S INV: 866.52 (8")

E INV: 866.52 (8"

E INV: 858.20 (6")

W INV: 858.68 (6")

E INV: 858.68 (6")

N INV: 858.68 (6")

E INV: 859.13 (6")

W INV: 859.13 (6"

W INV: 866.76 (8")

E INV: 866.76 (8")

S INV: 866.76 (8")

W INV: 866.97 (8")

E INV: 866.97 (8")

S INV: 866.97 (8")

W INV: 867.42 (8")

SE INV: 867.42 (8")

NW INV: 868.13 (8")

S INV: 868.13 (8"

N INV: 858.70 (6")

TO

STO A

STO A-1

STO DB B

STO D

STO C-1 STO DB C

LABEL

STO DB -1

STO DB B

STO DB C

STO DB E

LABEL

868.95

861.24

861.31

869.23

870.14

872.22

874.44

861.44

FROM

STO A-1

STO B-1

INVERT EL. (FT) DEPTH (FT) STRUCTURE DESC.

3.0

2.5

PROPOSED STORM SEWER PIPE TABLE

864.00

24 IN DB


12 IN DB

24 IN DB


LENGTH INVERT EL. (FT) DISCHARGE EL. (FT) SLOPE SIZE & MATERIAL

862.00

UTILITY PLAN

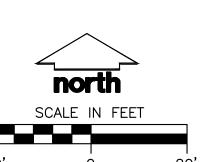

C500

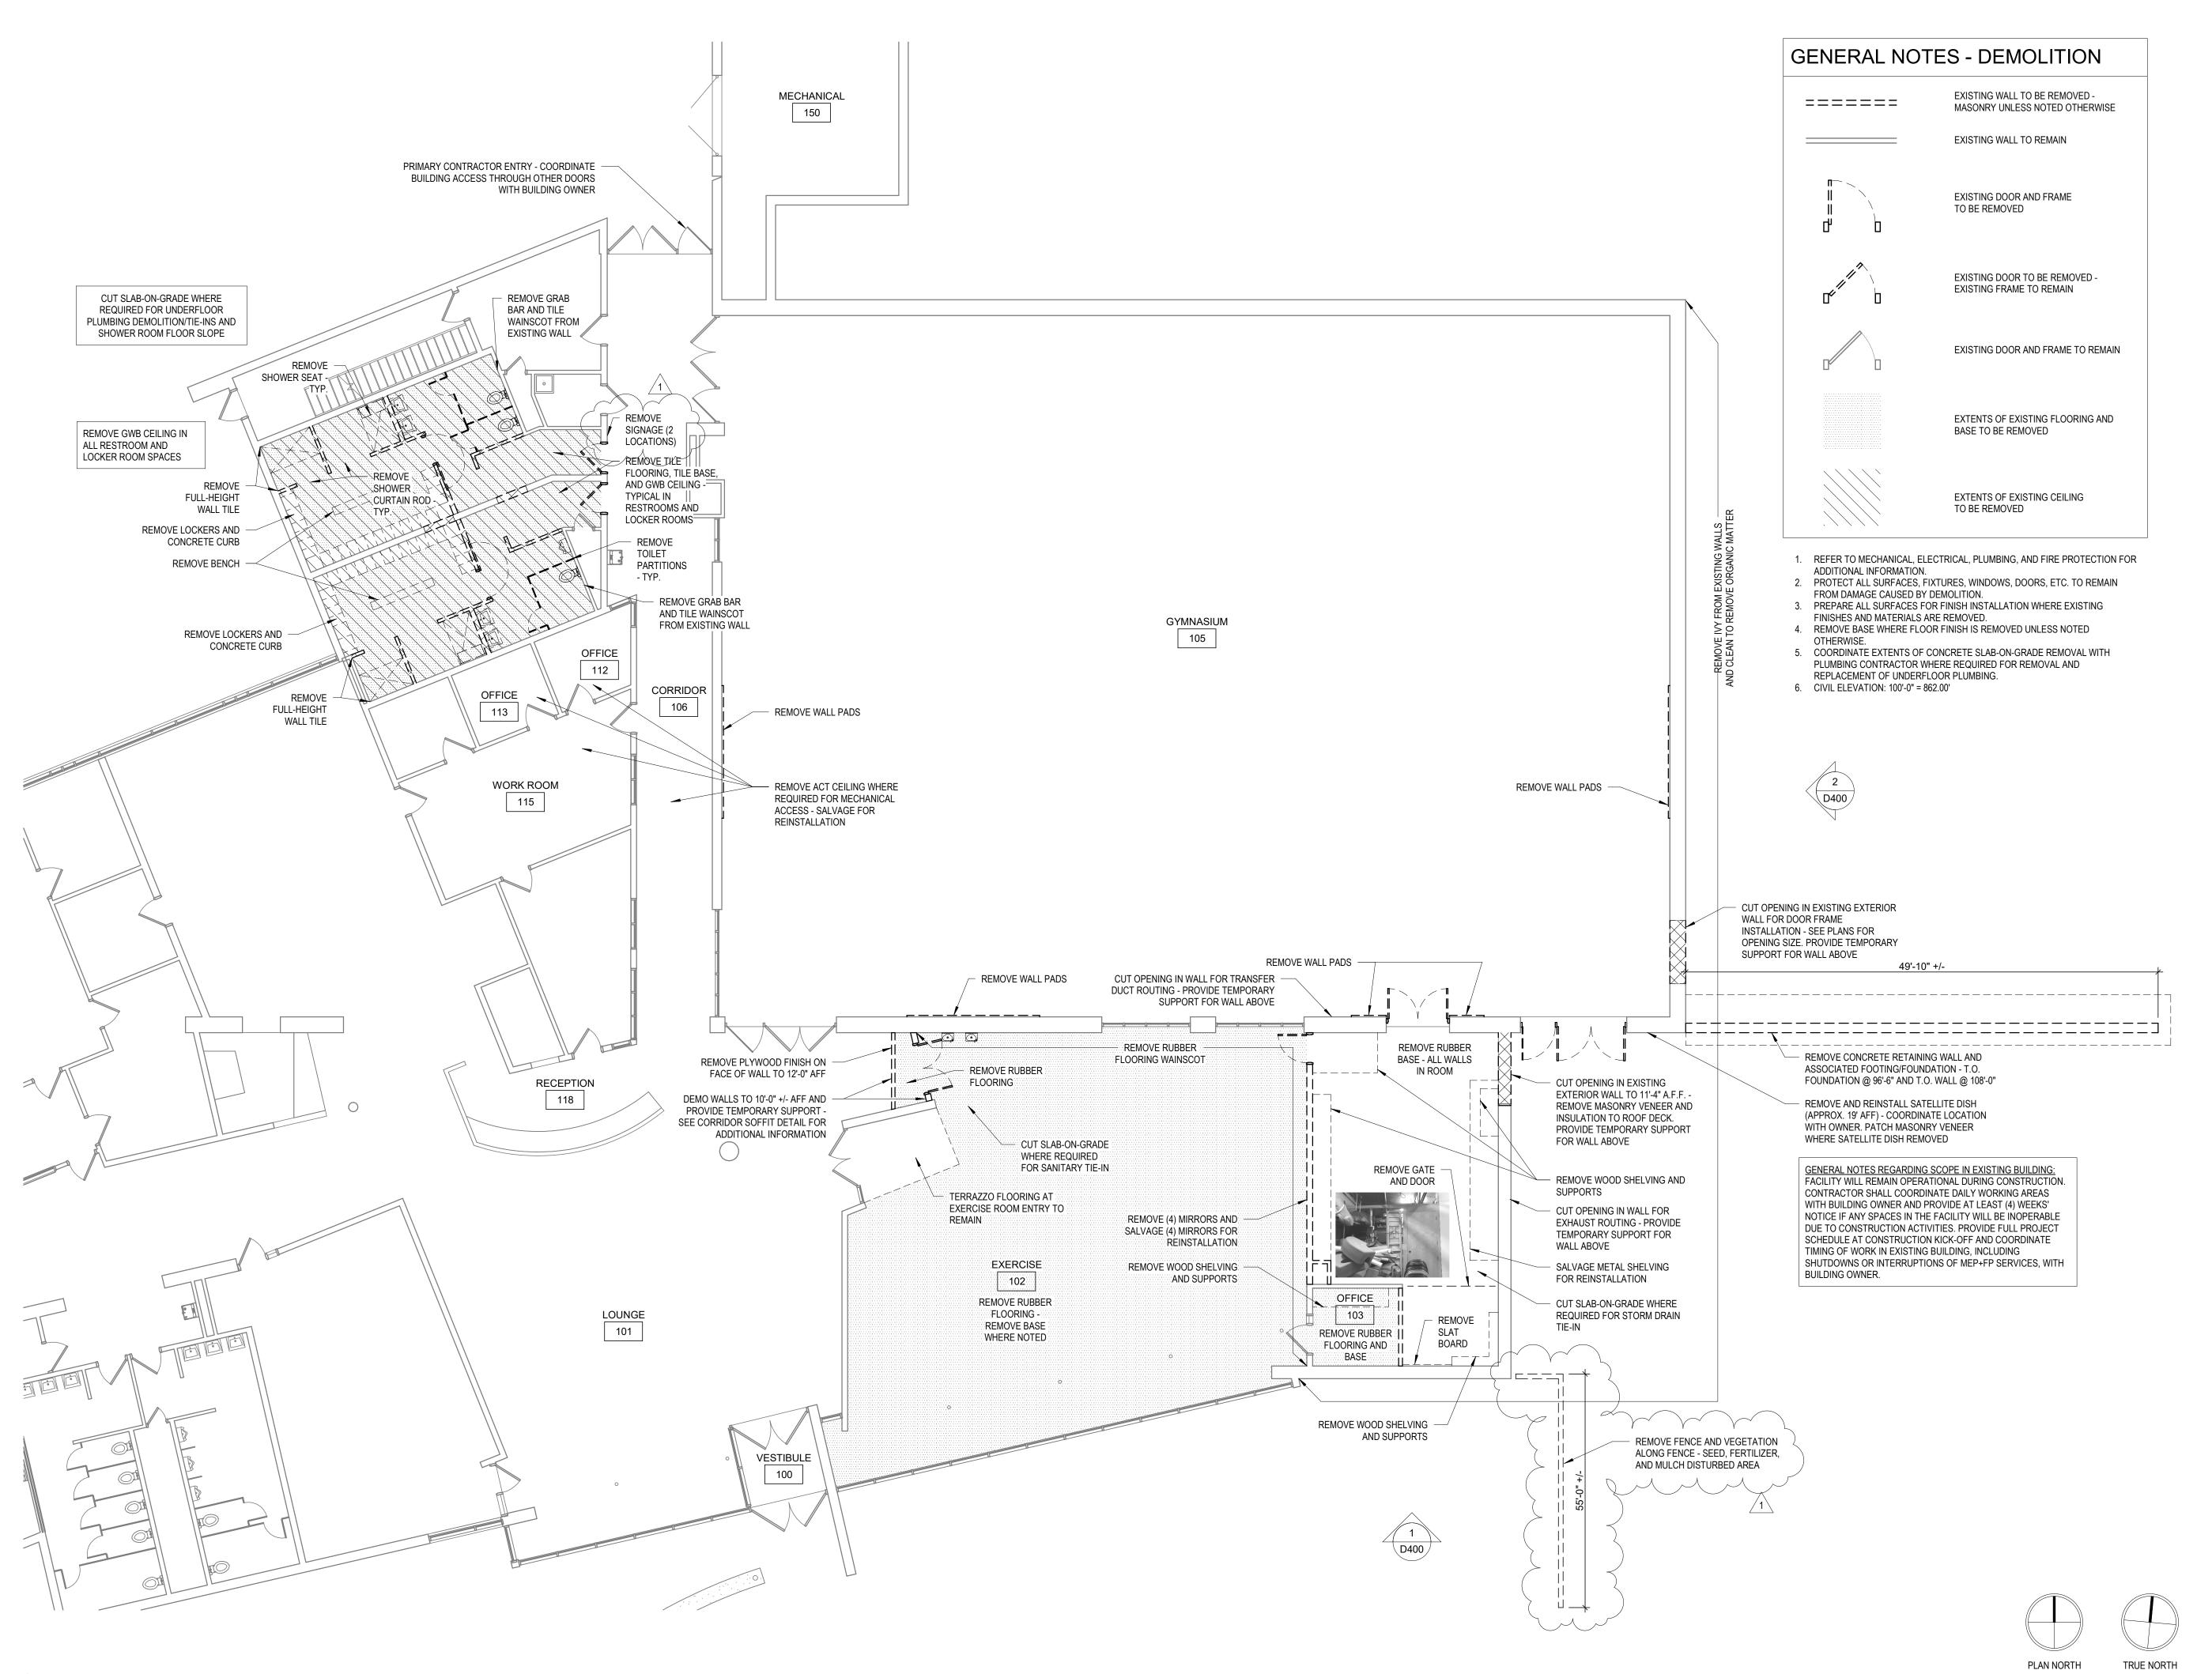



WARNER PARK
COMMUNITY RECREATION
CENTER EXPANSION

1625 NORTHPORT DRIVE MADISON, WI 53704 CITY OF MADISON PARKS DIVISION

330 EAST LAKESIDE STREET MADISON, WI 53715

PROJECT NUMBER

ISSUED FOR:

REVISION FOR:

**BID SET** 

NO. DESCRIPTION

1 ADDENDUM #2

223471.00

5/16/2024

DATE

6/13/2024

DRAWN BY

CHECKED BY

**DEMOLITION PLAN** 

D101

# WARNER PARK COMMUNITY RECREATION CENTER EXPANSION

1625 NORTHPORT DRIVE MADISON, WI 53704 CITY OF MADISON PARKS DIVISION 330 EAST LAKESIDE STREET

MADISON, WI 53715

PROJECT NUMBER

223471.00

DATE

6/13/2024

ISSUED FOR:
BID SET 5/16/2024

REVISION FOR:


NO. DESCRIPTION

1 ADDENDUM #2

DRAWN BY DKB


DEMOLITION ELEVATIONS

CHECKED BY

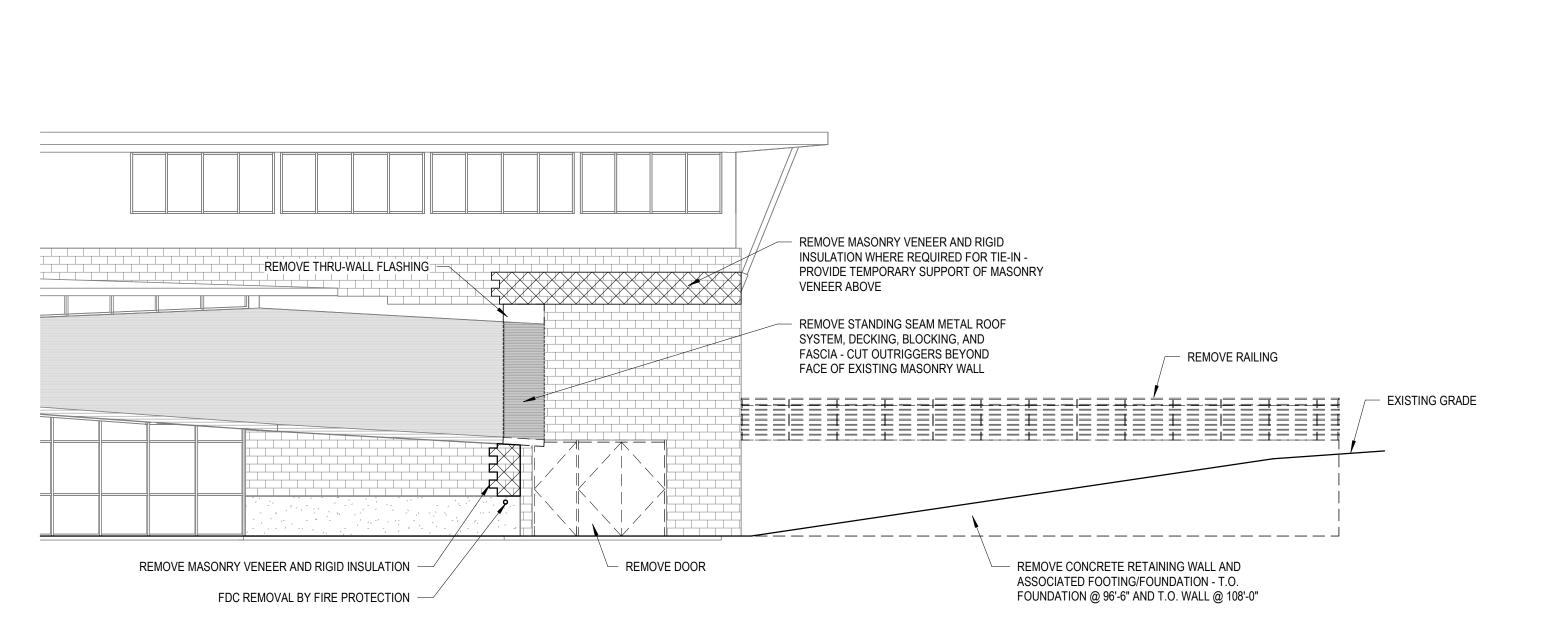


SOUTH DEMOLITION ELEVATION
SCALE: 1/8" = 1'-0"

D400

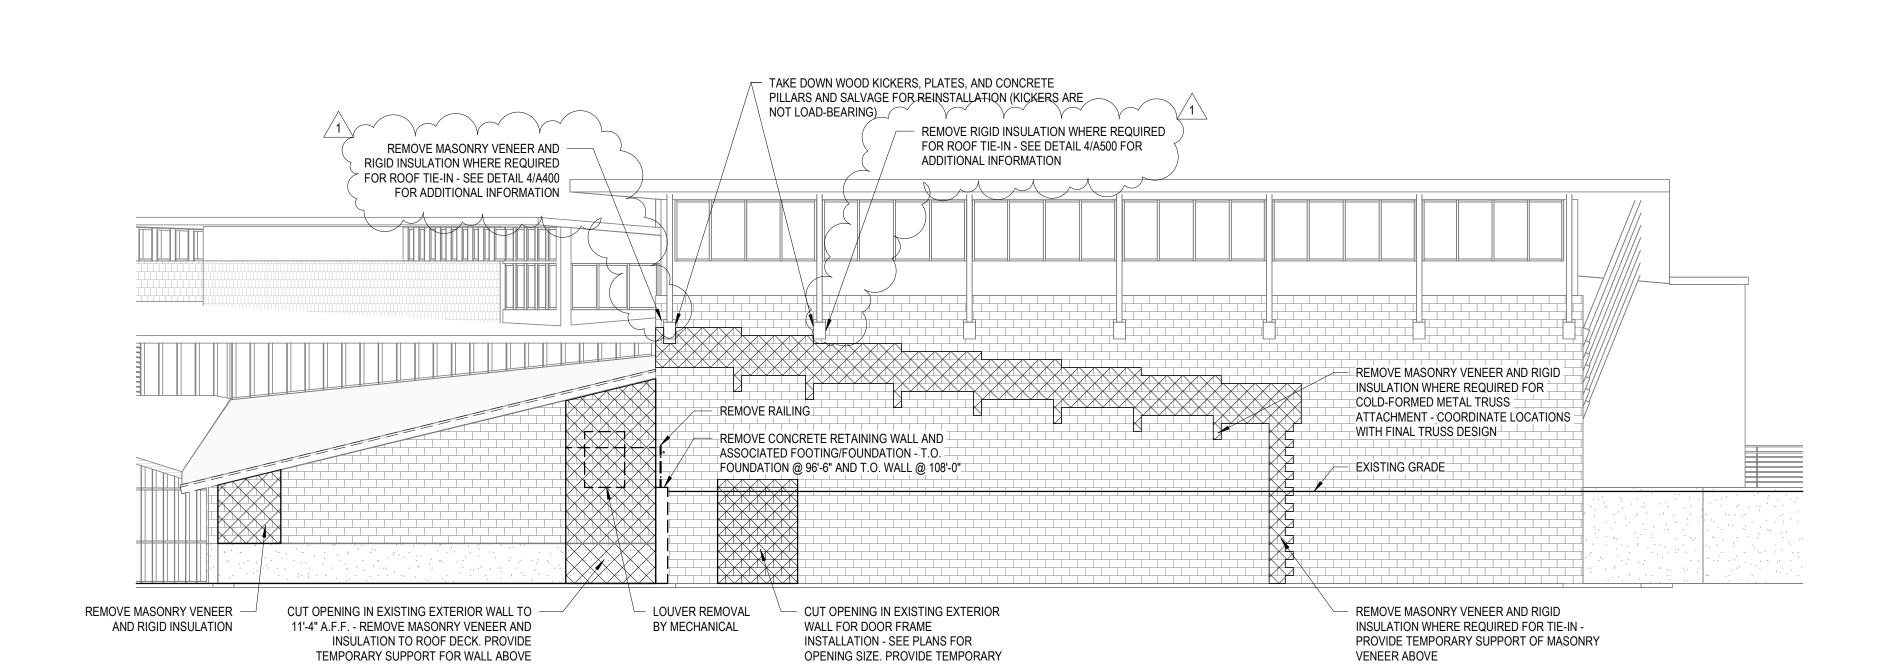

SUPPORT FOR WALL ABOVE

EAST DEMOLITION ELEVATION
SCALE: 1/8" = 1'-0"

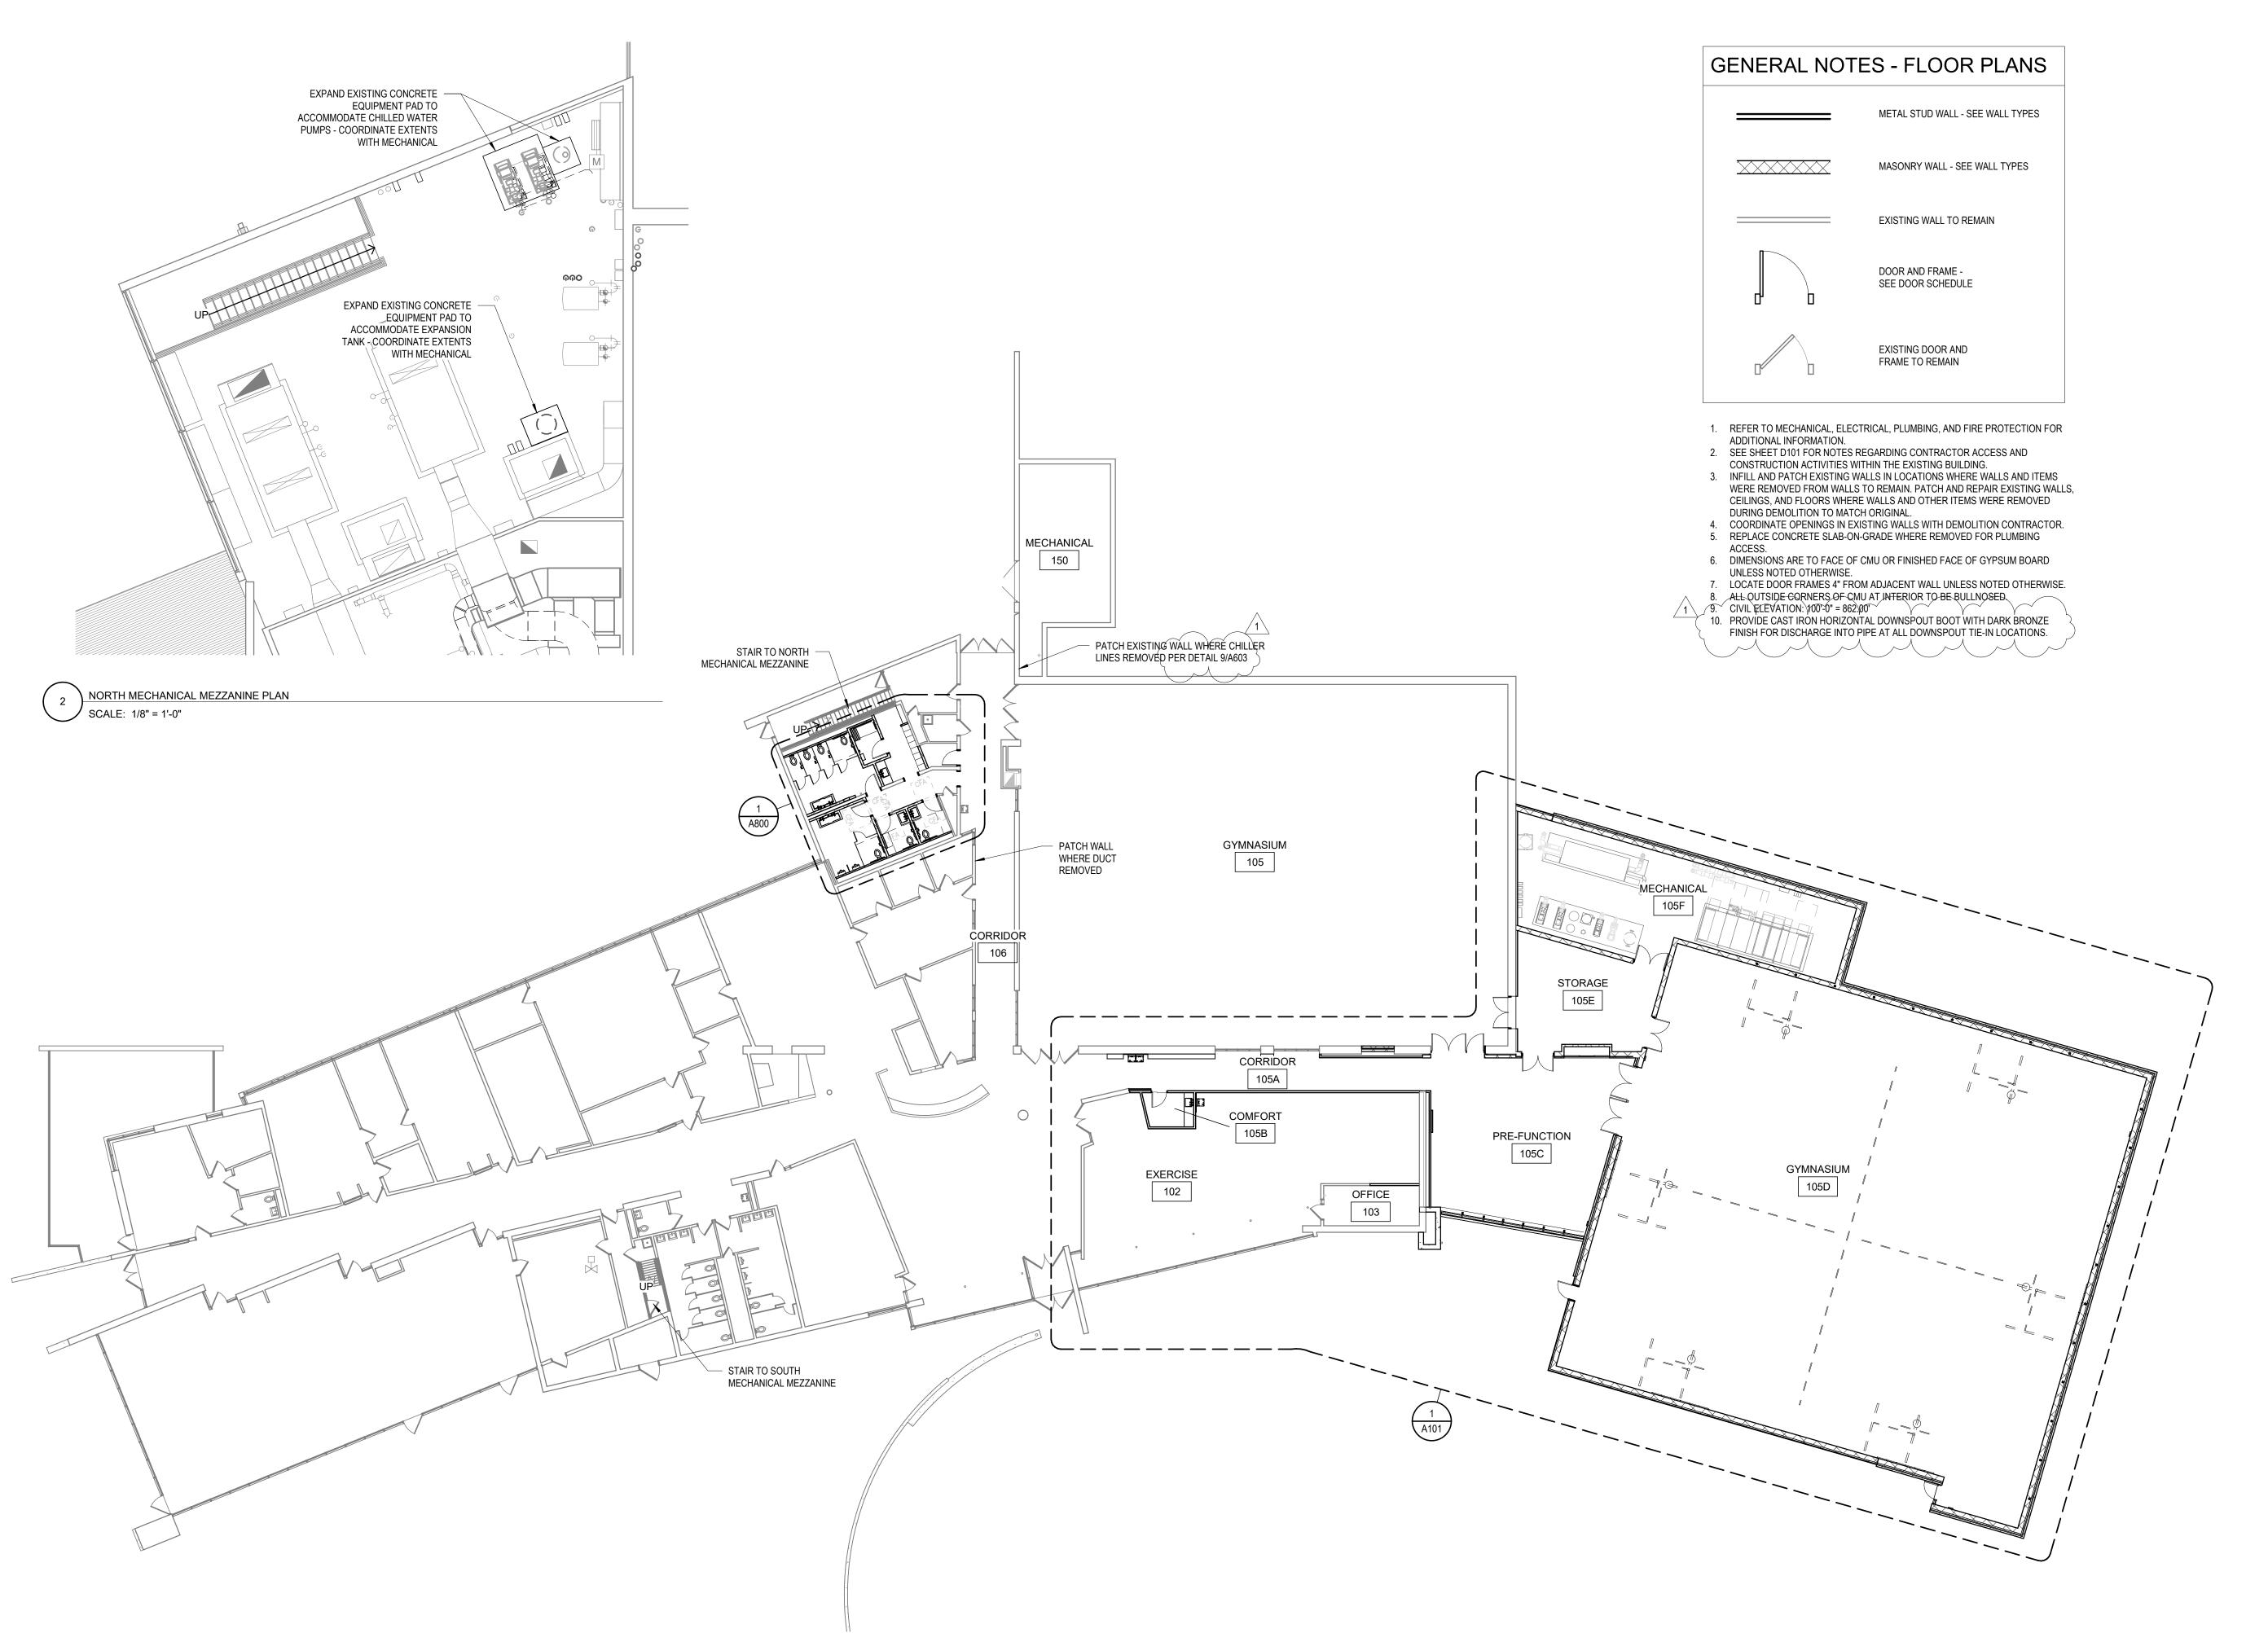



# WARNER PARK COMMUNITY RECREATION CENTER EXPANSION

223471.00

1625 NORTHPORT DRIVE MADISON, WI 53704

CITY OF MADISON PARKS DIVISION 330 EAST LAKESIDE STREET MADISON, WI 53715

PROJECT NUMBER

ISSUED FOR:

BID SET 5/16/2024

REVISION FOR:


NO. DESCRIPTION DATE


1 ADDENDUM #2 6/13/2024

DRAWN BY DKB

CHECKED BY JWH

OVERALL FLOOR PLAN

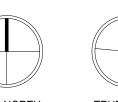

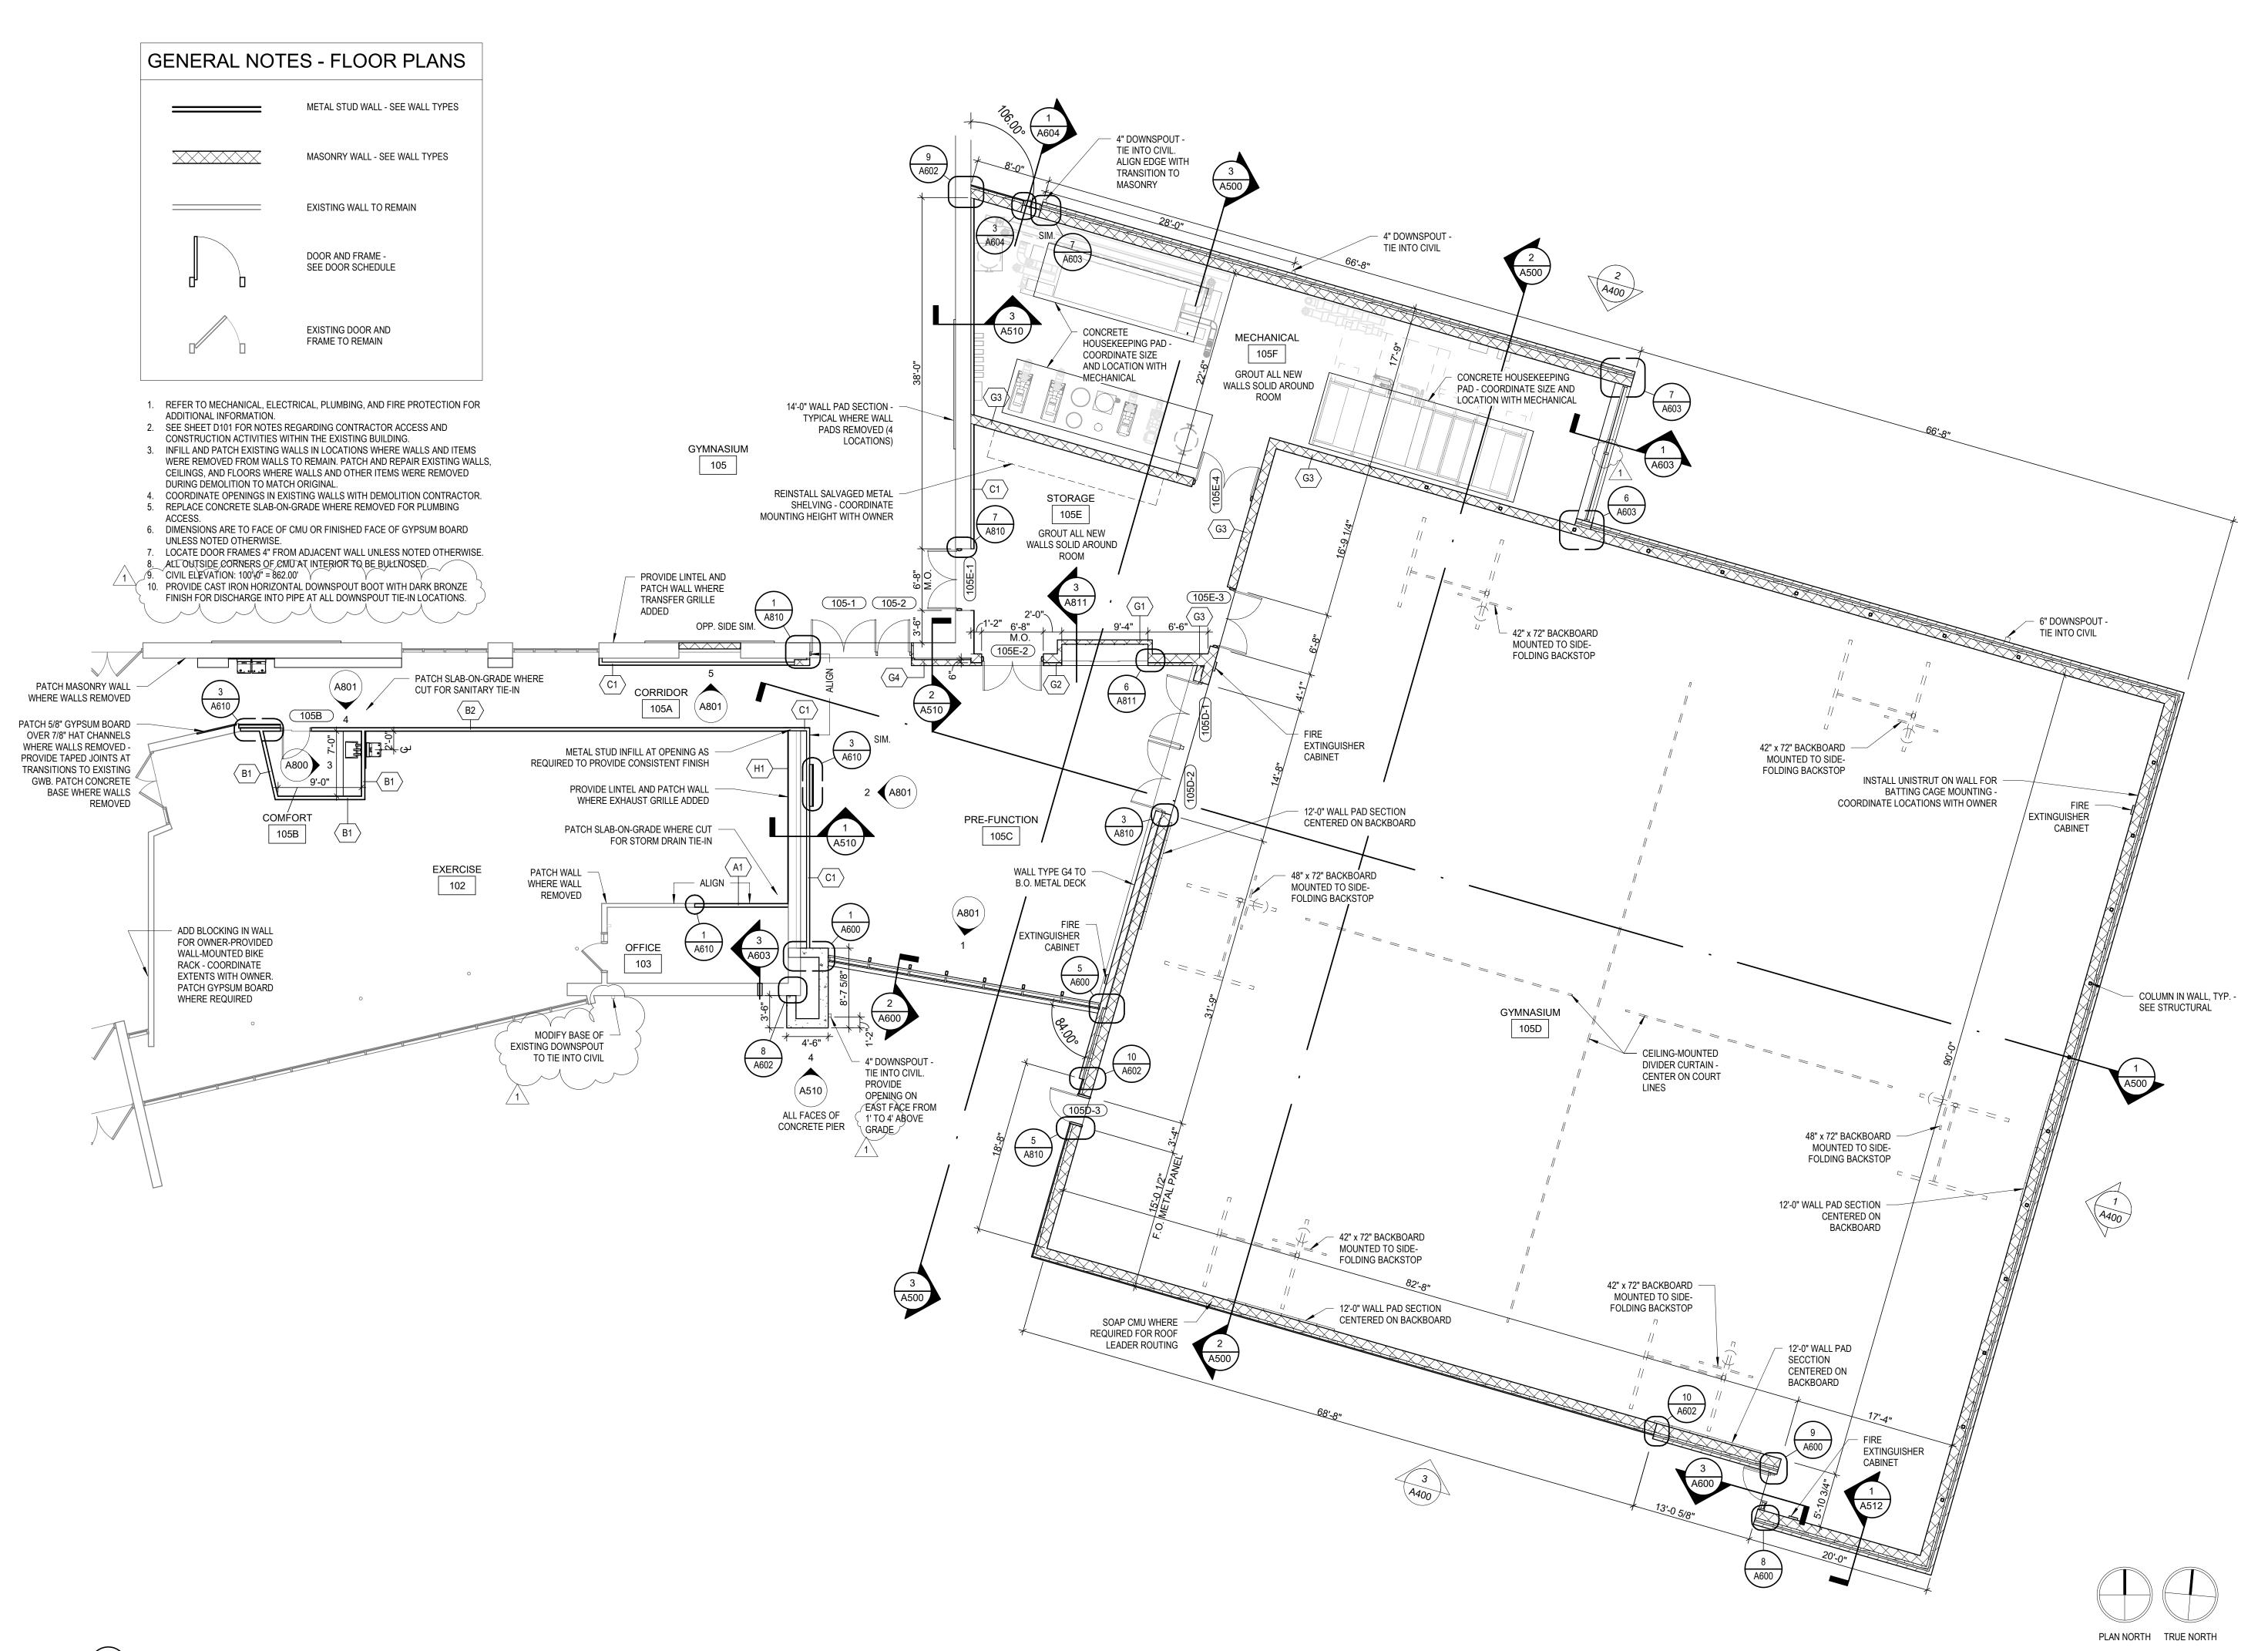



# WARNER PARK COMMUNITY RECREATION CENTER EXPANSION

223471.00

1625 NORTHPORT DRIVE MADISON, WI 53704 CITY OF MADISON PARKS DIVISION

330 EAST LAKESIDE STREET MADISON, WI 53715

PROJECT NUMBER

ISSUED FOR:

BID SET 5/16/2024

REVISION FOR:

NO. DESCRIPTION DATE


1 ADDENDUM #2 6/13/2024

DRAWN BY DKE

**EXPANSION FLOOR PLAN** 

CHECKED BY

A101

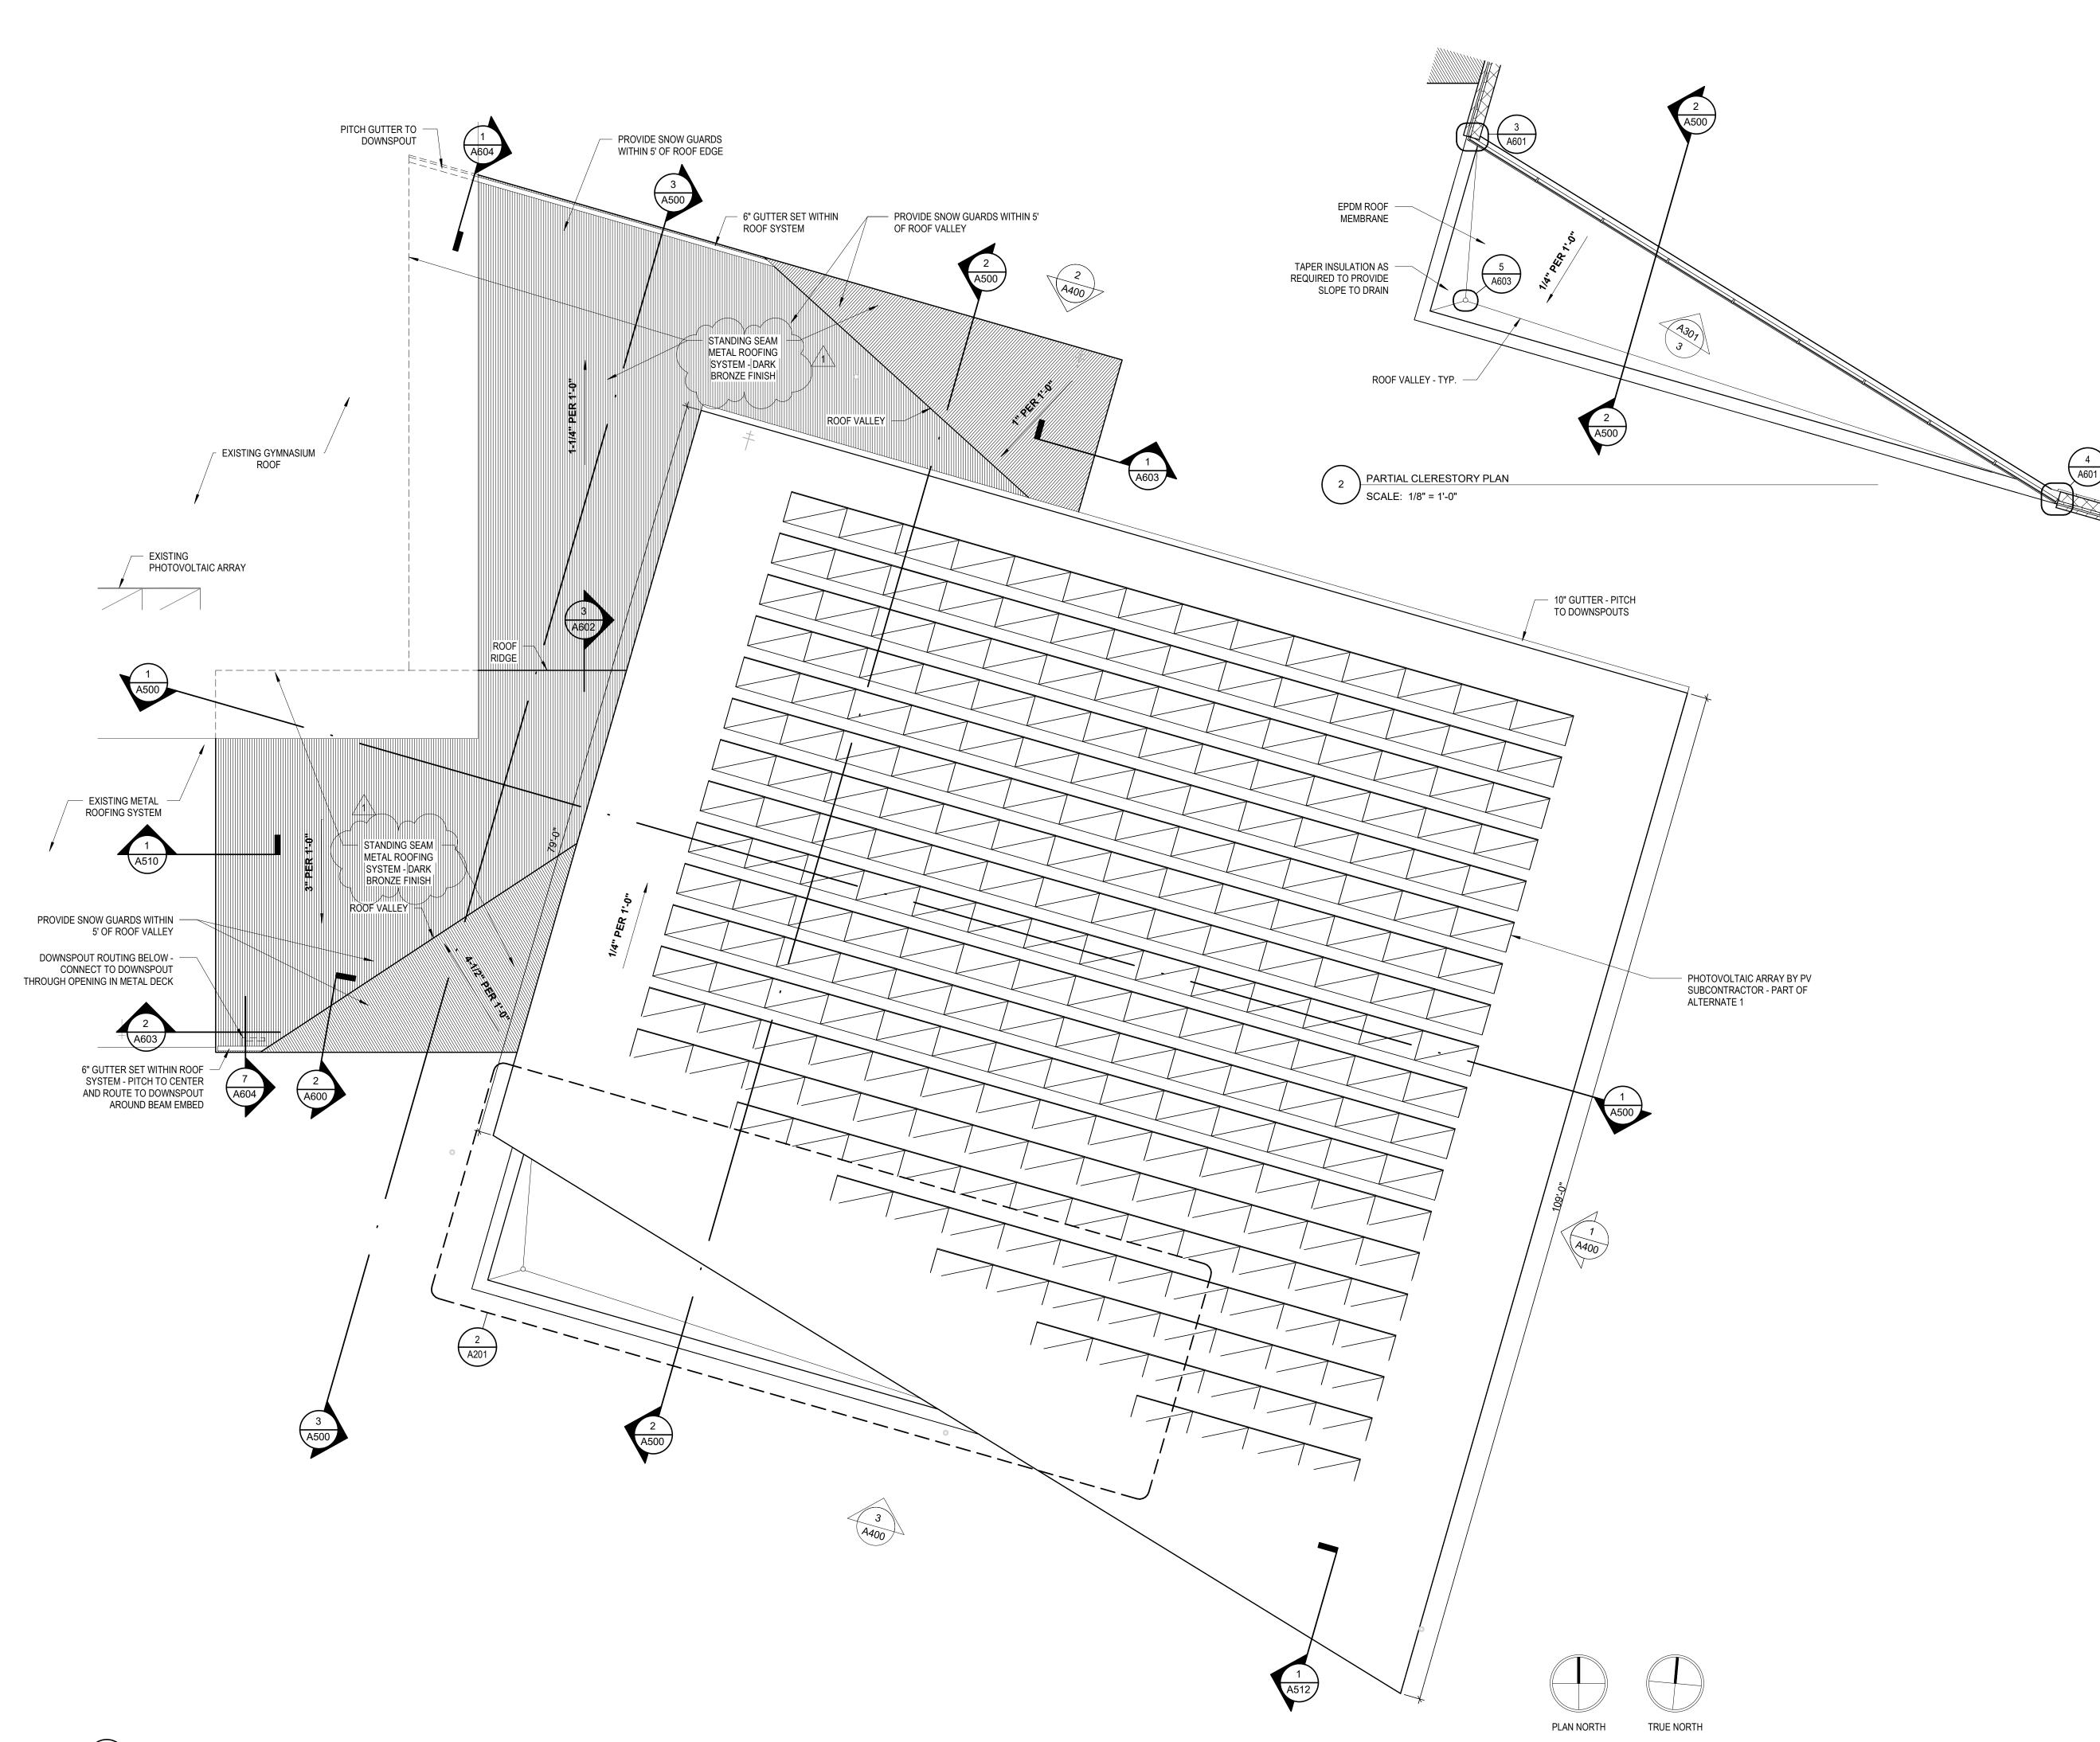



# WARNER PARK COMMUNITY RECREATION CENTER EXPANSION

1625 NORTHPORT DRIVE MADISON, WI 53704 CITY OF MADISON PARKS DIVISION 330 EAST LAKESIDE STREET

PROJECT NUMBER

MADISON, WI 53715

223471.00

ISSUE	O FOR:	
BID SI	ET	5/16/2024
REVISI	ON FOR:	
NO.	DESCRIPTION	DATE


1 ADDENDUM #2

6/13/2024

DRAWN BY DKB
CHECKED BY JWH

EXPANSION ROOF PLAN

**A201** 

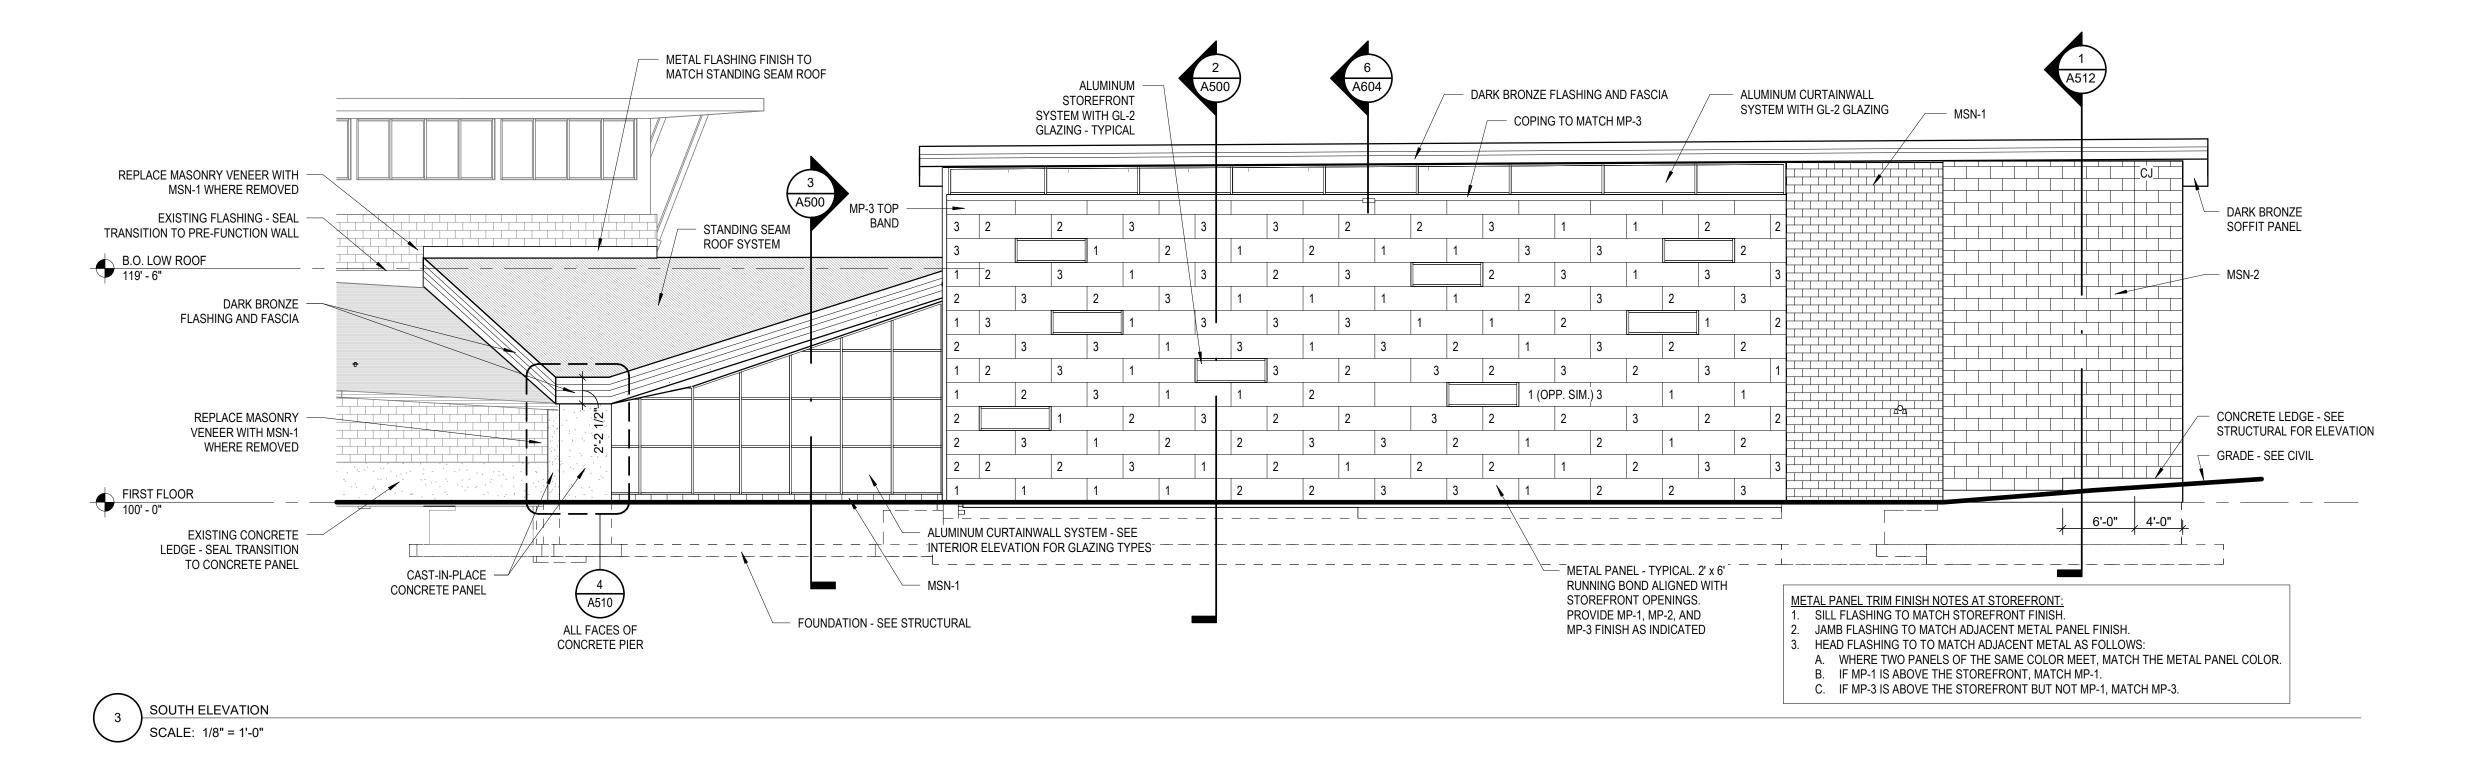



# WARNER PARK COMMUNITY RECREATION **CENTER EXPANSION**

1625 NORTHPORT DRIVE MADISON, WI 53704 CITY OF MADISON PARKS DIVISION 330 EAST LAKESIDE STREET

PROJECT NUMBER

MADISON, WI 53715

223471.00

NO. DESCRIPTION 1 ADDENDUM #2

DATE


6/13/2024


ISSUED FOR: 5/16/2024 **BID SET REVISION FOR:** 

CHECKED BY

DRAWN BY

**EXTERIOR ELEVATIONS** 

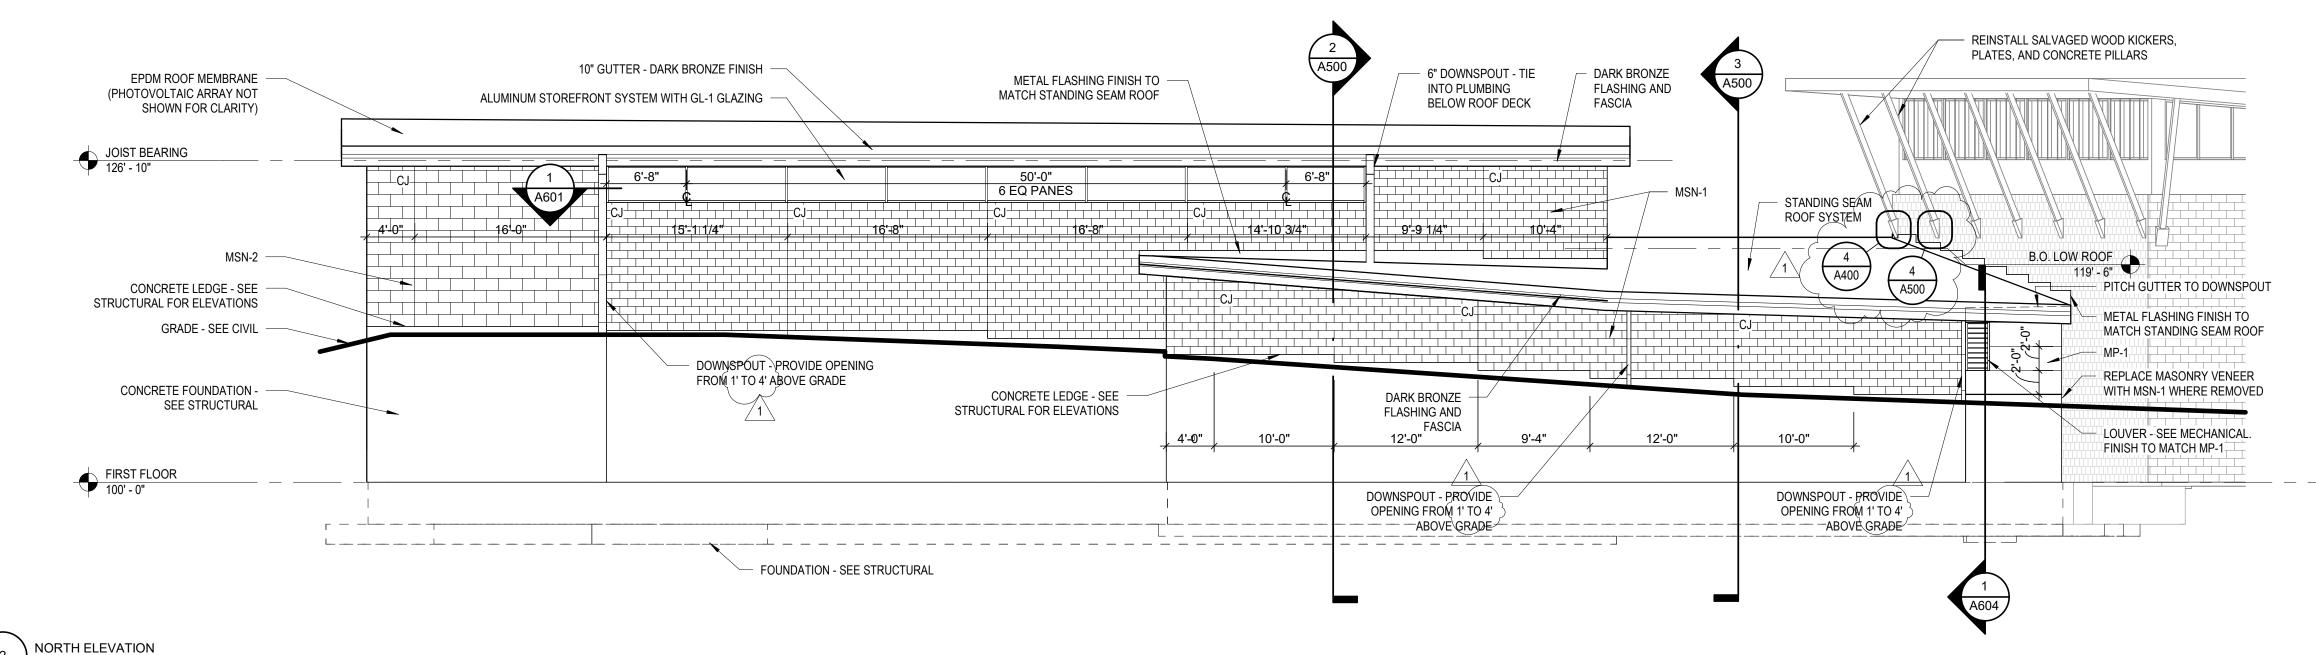

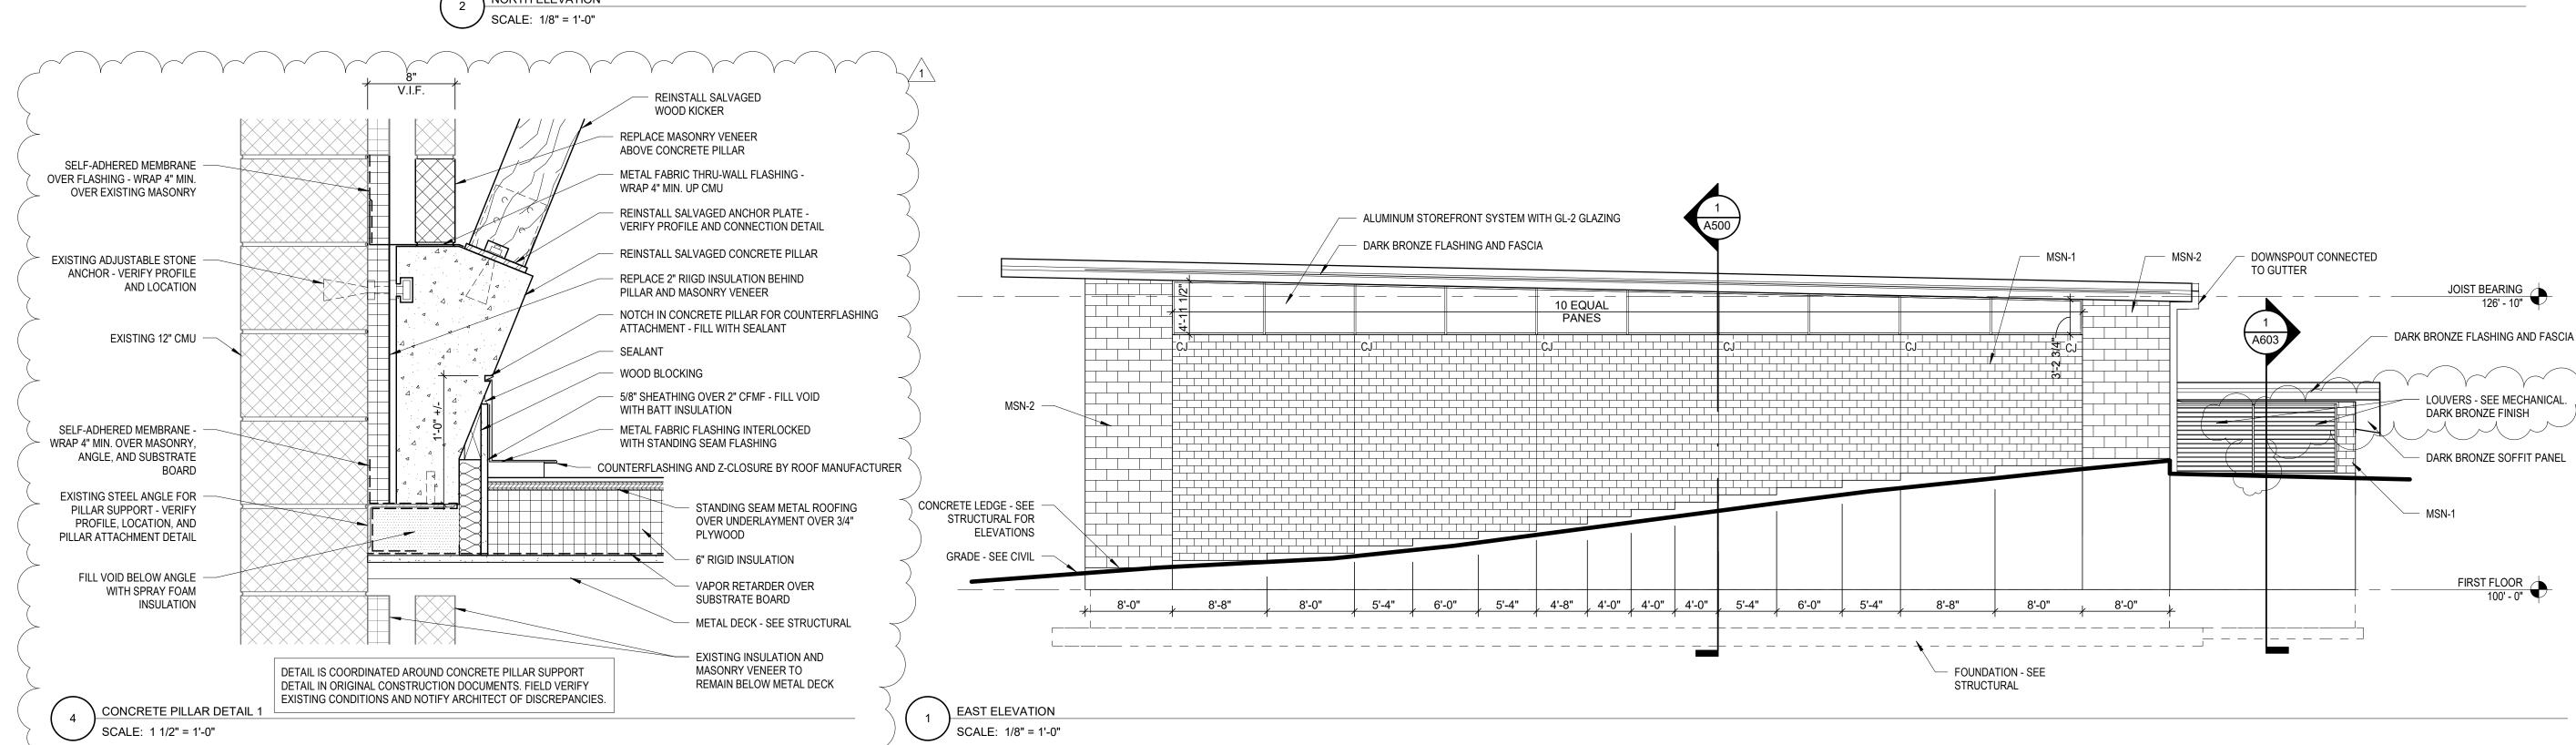

**EXTERIOR FINISH LEGEND** 

TEXTURE: SPLITFACE

COLOR: OAK RIDGE

TEXTURE: SMOOTH

8" x 16" RUNNING BOND PATTERN

12" x 24" RUNNING BOND PATTERN

24" x 72" RUNNING BOND PATTERN

24" x 72" RUNNING BOND PATTERN

COLOR: EN-V 008 CITYSCAPE

COLOR: DRI-005 SIERRA TAN

COLOR: EN-V 009 SLATE GRAY

24" x 72" RUNNING BOND PATTERN


DRI-DESIGN EN-V METAL PANEL SYSTEM

DRI-DESIGN EN-V METAL PANEL SYSTEM

DRI-DESIGN EN-V METAL PANEL SYSTEM

ARRISCRAFT THIN-CLAD RENAISSANCE UNITS

COUNTY MATERIALS DECORATIVE CONCRETE MASONRY COLOR: 18-121C BISQUE (MATCHED TO EXISTING)

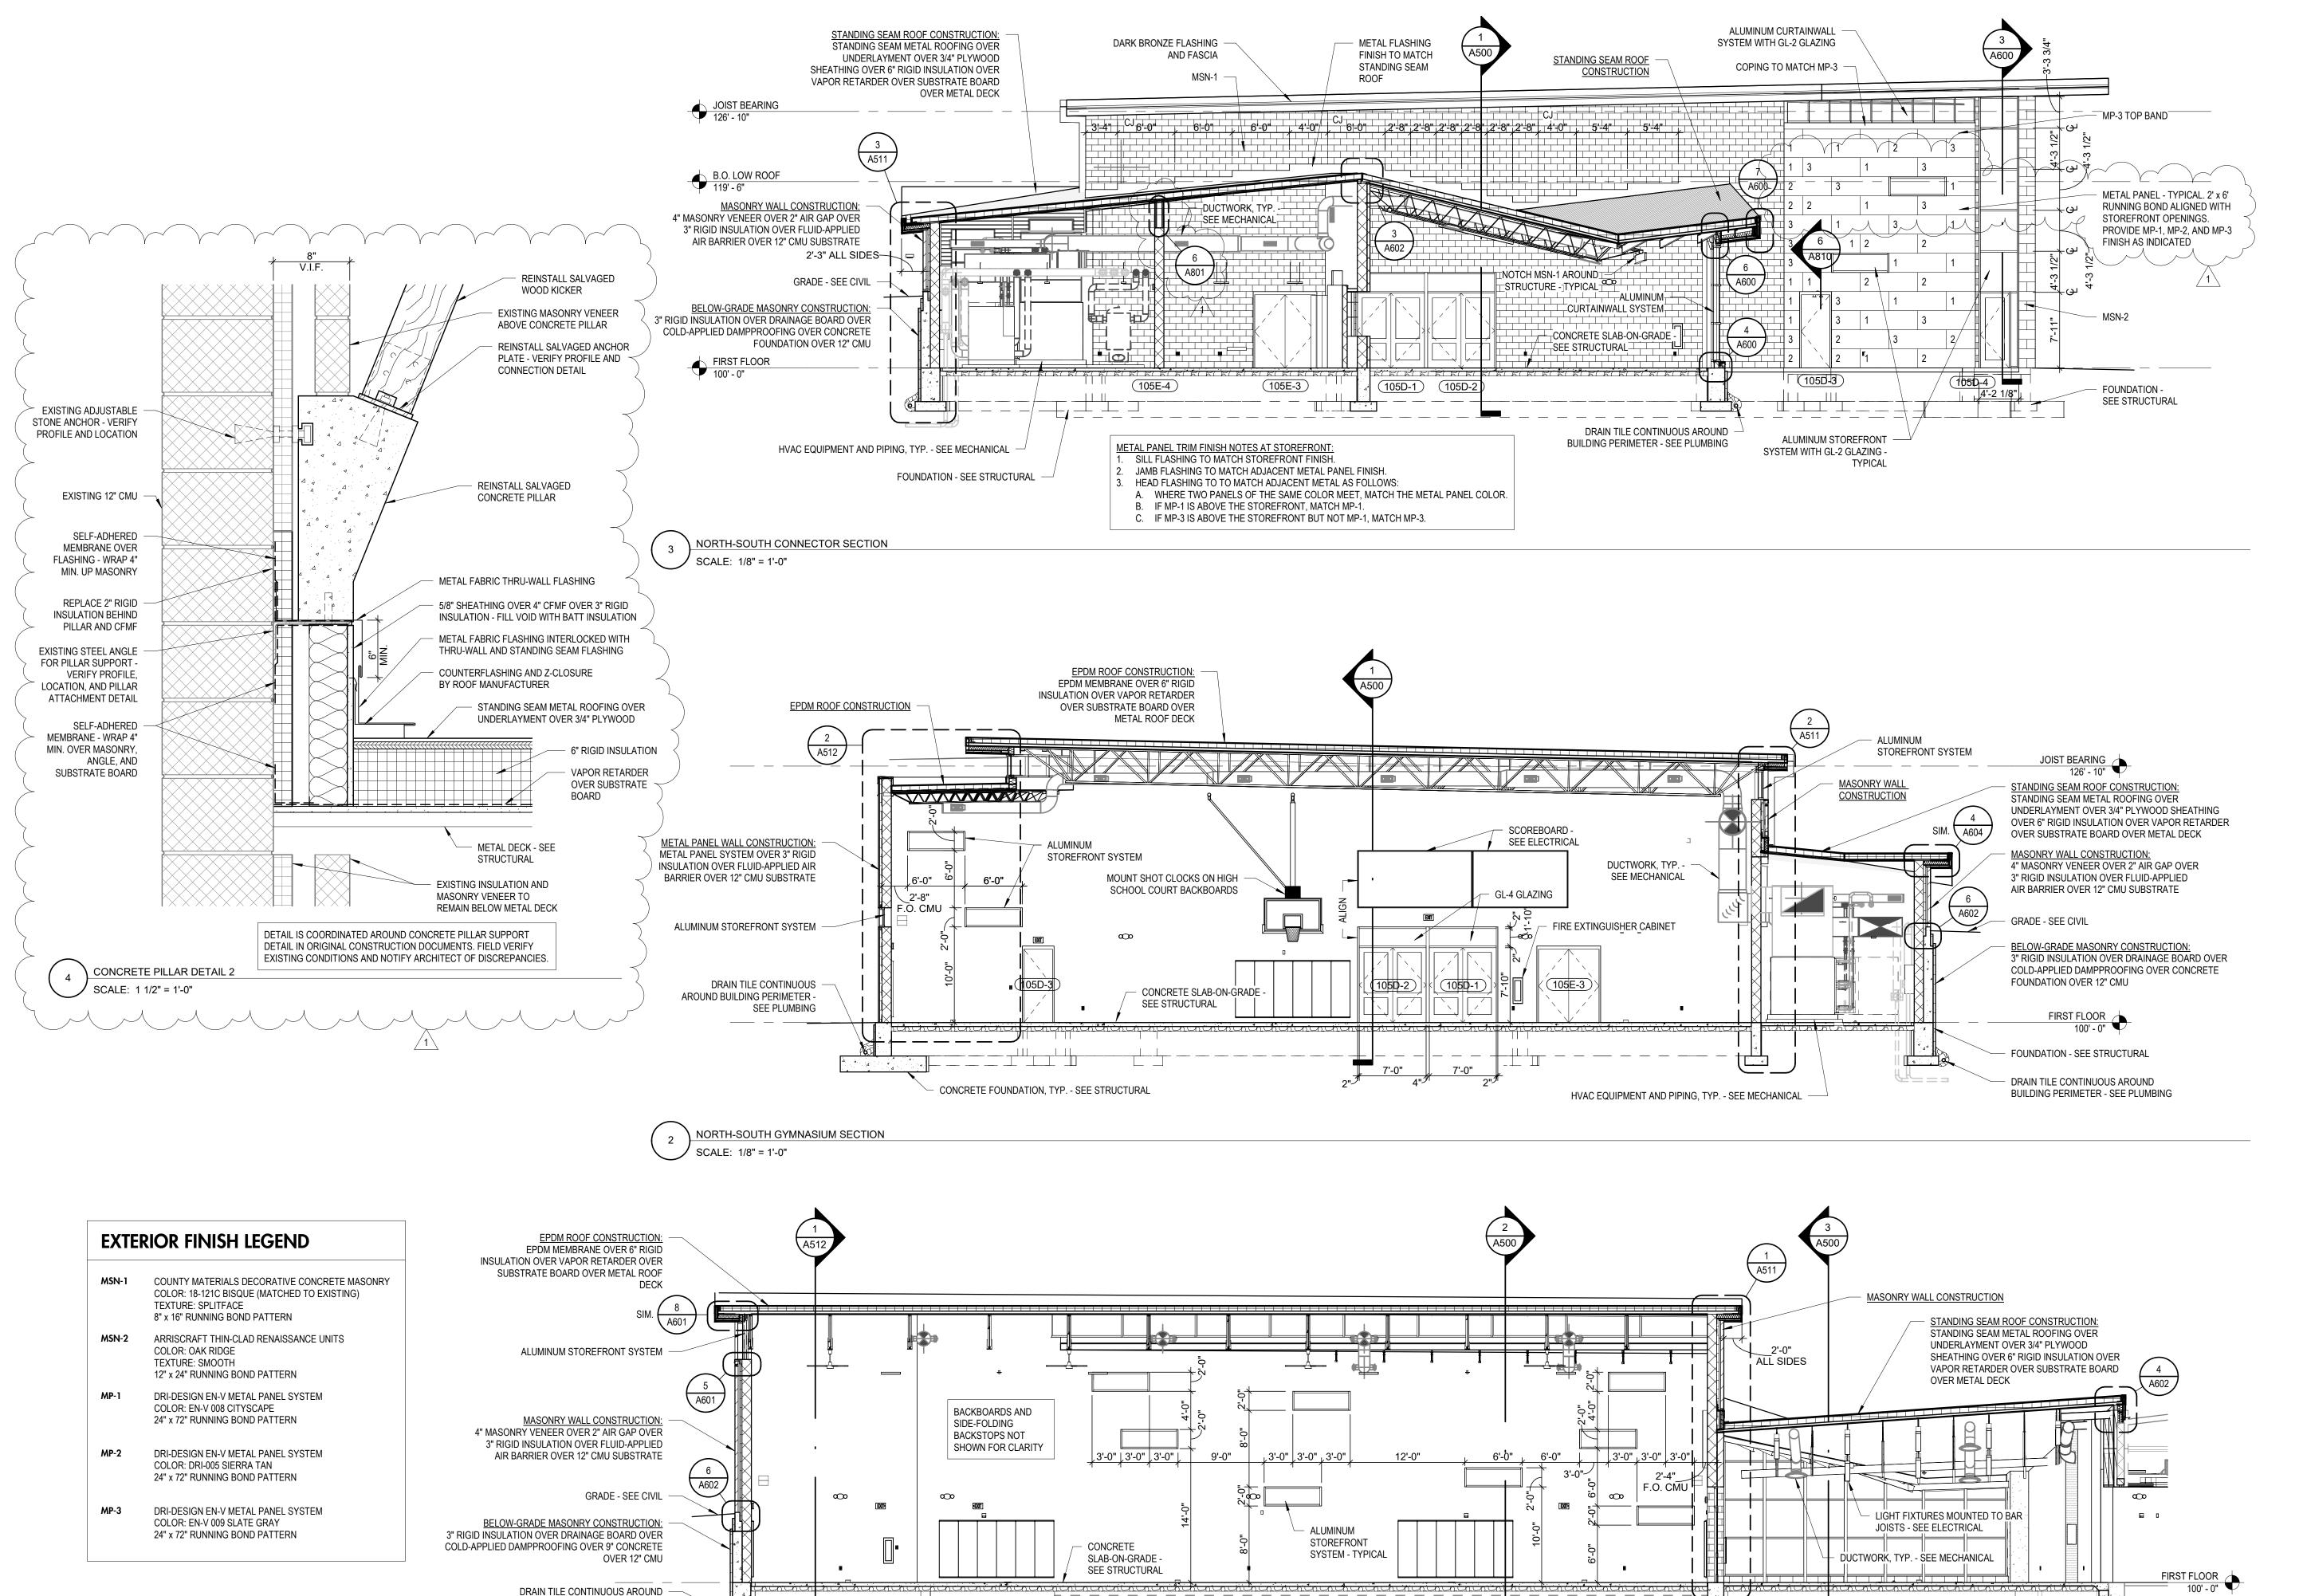

BUILDING PERIMETER - SEE PLUMBING

EAST-WEST EXPANSION SECTION

CONCRETE FOUNDATION, TYP. SEE STRUCTURAL

SCALE: 1/8" = 1'-0"



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# WARNER PARK COMMUNITY RECREATION CENTER EXPANSION

1625 NORTHPORT DRIVE MADISON, WI 53704 CITY OF MADISON PARKS DIVISION 330 EAST LAKESIDE STREET

PROJECT NUMBER

MADISON, WI 53715

223471.00

6/13/2024

ISSUED FOR:

BID SET 5/16/2024

REVISION FOR:

NO. DESCRIPTION DATE

1 ADDENDUM #2

DRAWN BY DKB

**BUILDING SECTIONS** 

CHECKED BY


FOUNDATION TIED INTO

STRUCTURAL

**EXISTING FOUNDATION - SEE** 

A500



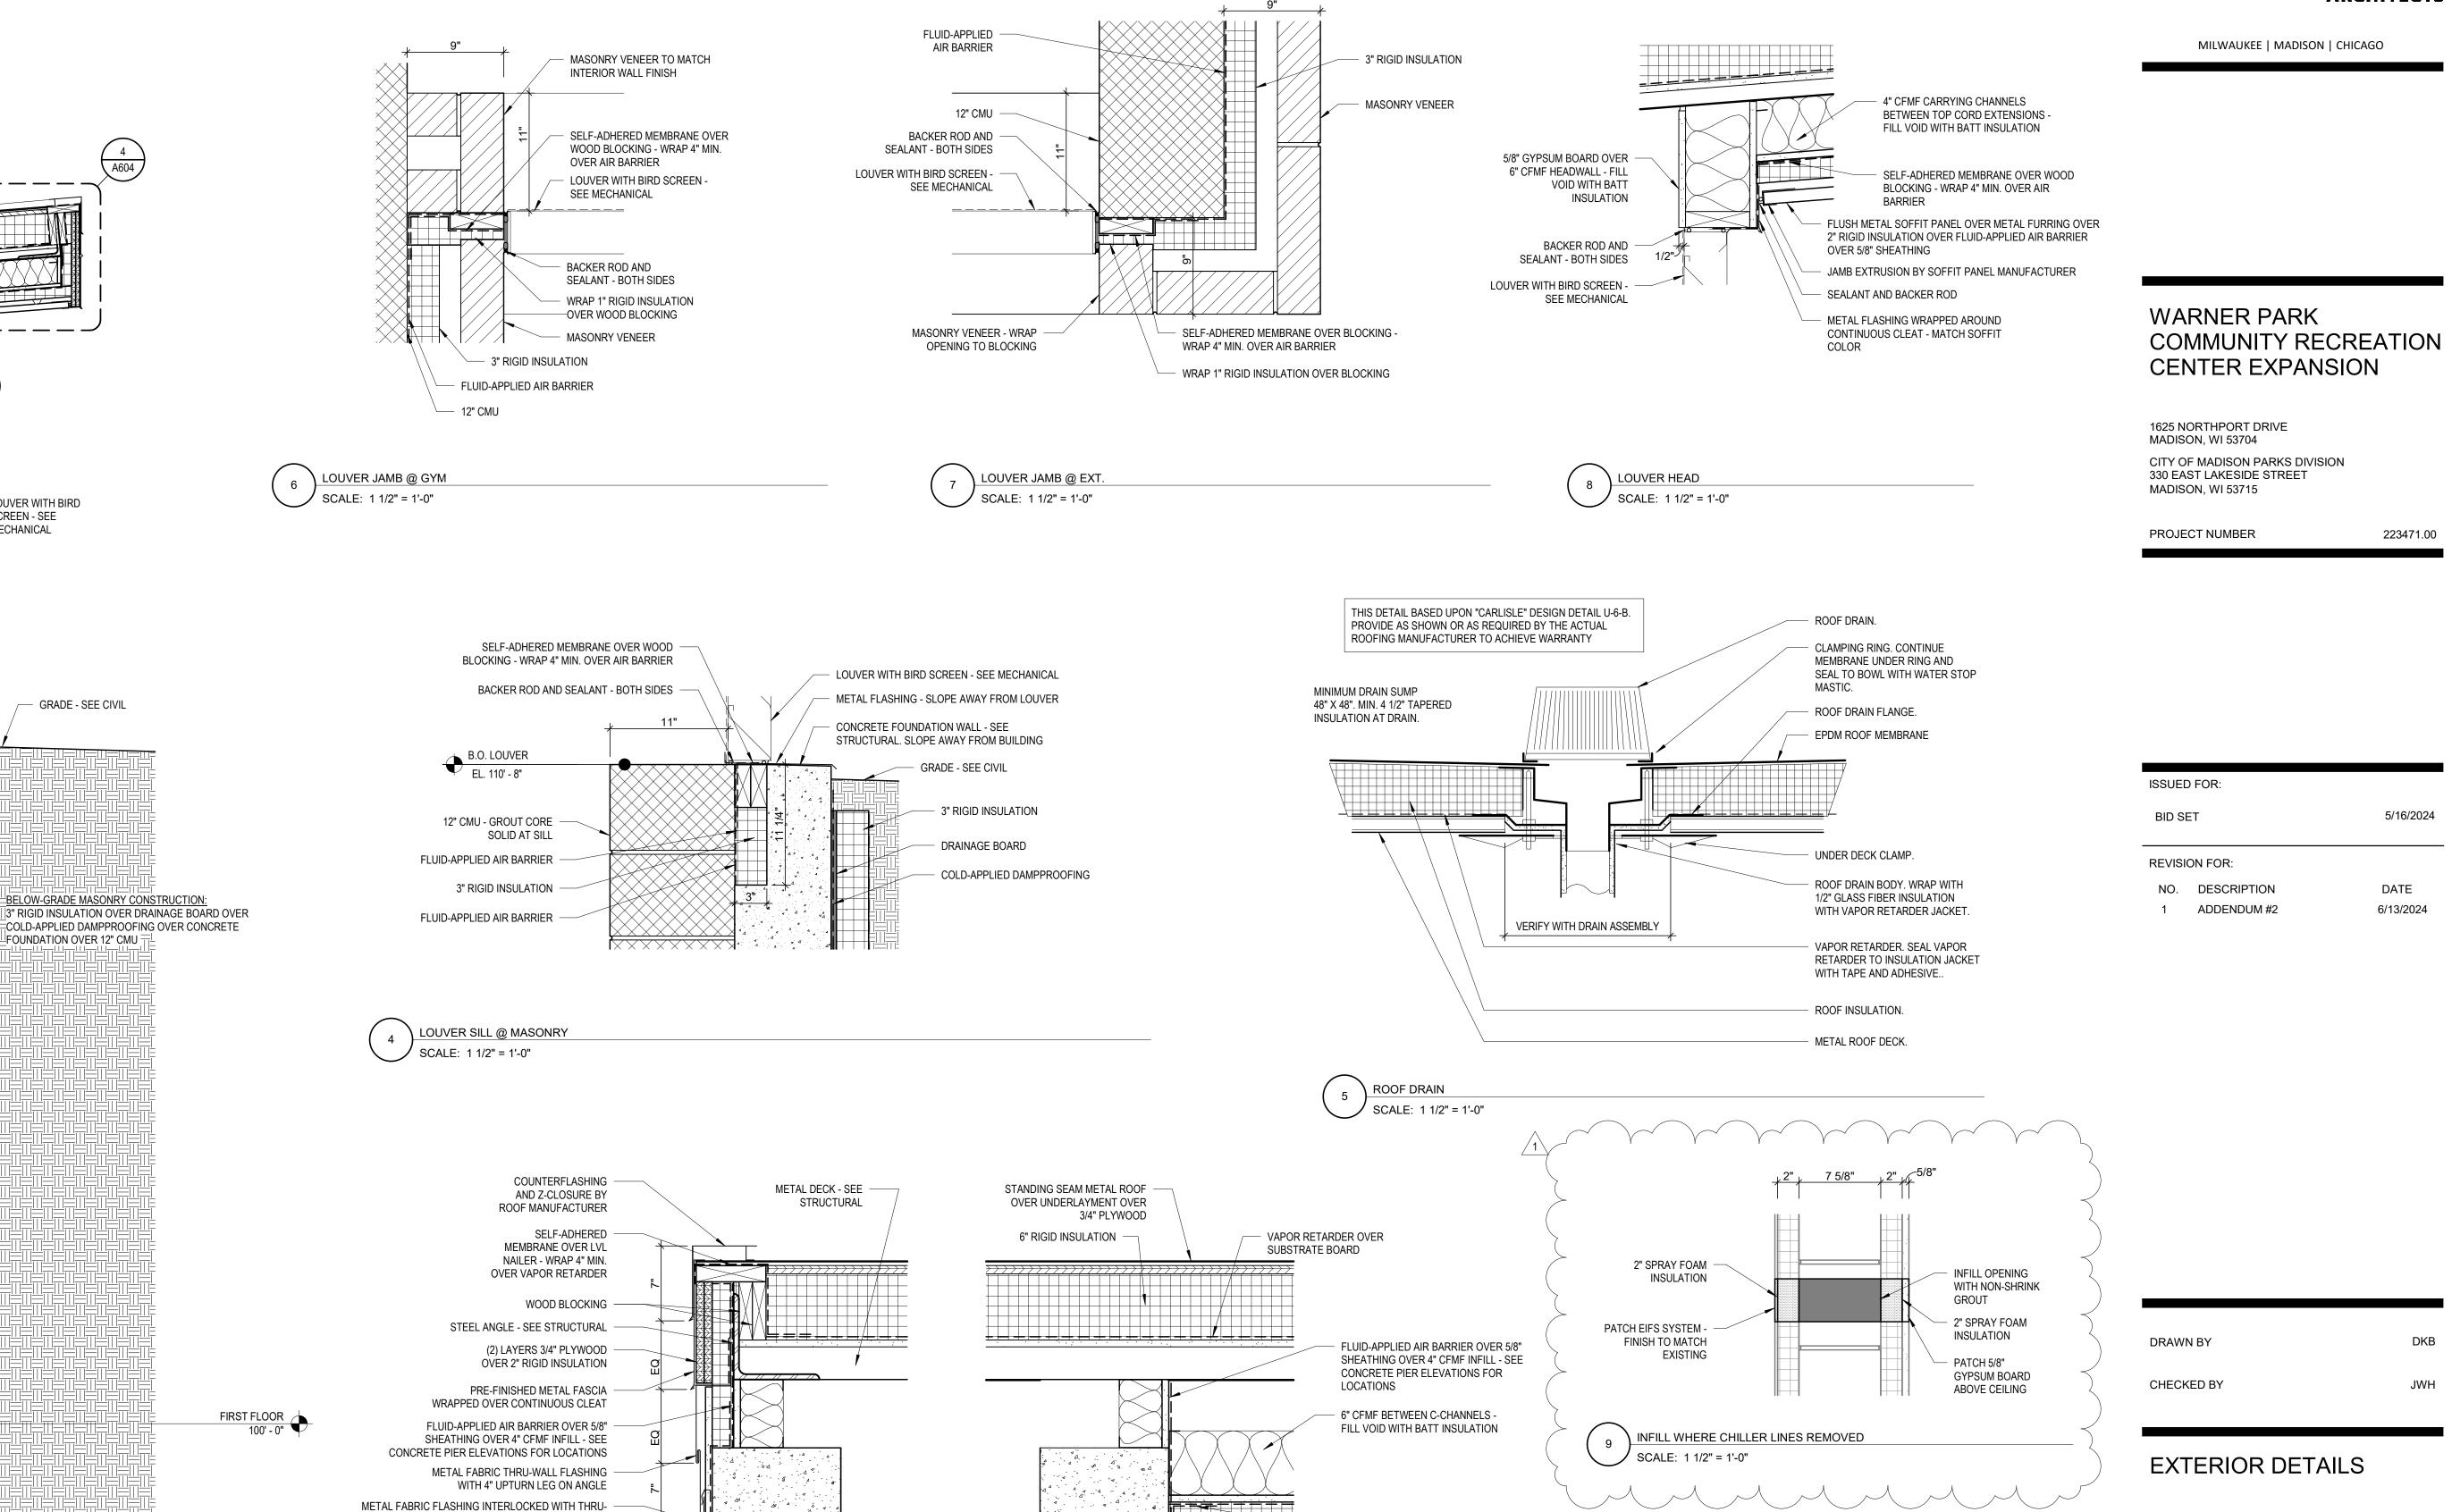

SELF-ADHERED MEMBRANE

FLUSH METAL SOFFIT PANEL OVER METAL FURRING OVER 2" RIGID INSULATION OVER FLUID-APPLIED AIR

OVER SHEATHING

BARRIER OVER 5/8" SHEATHING

JAMB EXTRUSION AND CLOSURE BY

CAST-IN-PLACE CONCRETE WALL, TYP.

SEE ELEVATIONS FOR LEDGE HEIGHTS

METAL SOFFIT MANUFACTURER

AND LOCATIONS

2 -1 4 - 1 A - 2

4 44 44

A603

INFILL OPENING

WITH NON-SHRINK GROUT

EAST WALL LOUVER SECTION SCALE: 3/4" = 1'-0"

1" RIGID INSULATION WITH SEALANT -

CONCRETE SLAB-ON-GRADE -

CONCRETE FOUNDATION -

SEE STRUCTURAL

SEE STRUCTURAL

STANDING SEAM ROOF CONSTRUCTION:

STANDING SEAM METAL ROOFING OVER

SHEATHING OVER 6" RIGID INSULATION OVER

VAPOR RETARDER OVER SUBSTRATE BOARD

UNDERLAYMENT OVER 3/4" PLYWOOD

A603

OVER METAL DECK

8 A603

LOUVER WITH BIRD SCREEN - SEE MECHANICAL

GRADE - SEE CIVIL

BELOW-GRADE MASONRY CONSTRUCTION:

 ${\sqcup \atop \sqsubseteq}$ FOUNDATION OVER 12" CMU  ${=\atop \shortmid}$ 

THE -SEE PLUMBING

> STANDING SEAM @ CONCRETE SCALE: 1 1/2" = 1'-0"

WALL AND STANDING SEAM FLASHING

SEALANT AND BACKER ROD

ALONG EXISTING ROOF PROFILE

WHERE CUT AT CONCRETE WALL

SEAM METAL ROOF

WRAP SELF-ADHERED MEMBRANE 4"

MIN. OVER PLYWOOD - PATCH RIGID

INSULATION WHERE REQUIRED

COUNTERFLASHING AND Z-CLOSURE

COMPATIBLE WITH EXISTING STANDING

INFILL WHERE FDC REMOVED SCALE: 1 1/2" = 1'-0"


2" SPRAY FOAM

PATCH 6" CONCRETE -

FINISH TO MATCH

INSULATION

**EXISTING** 

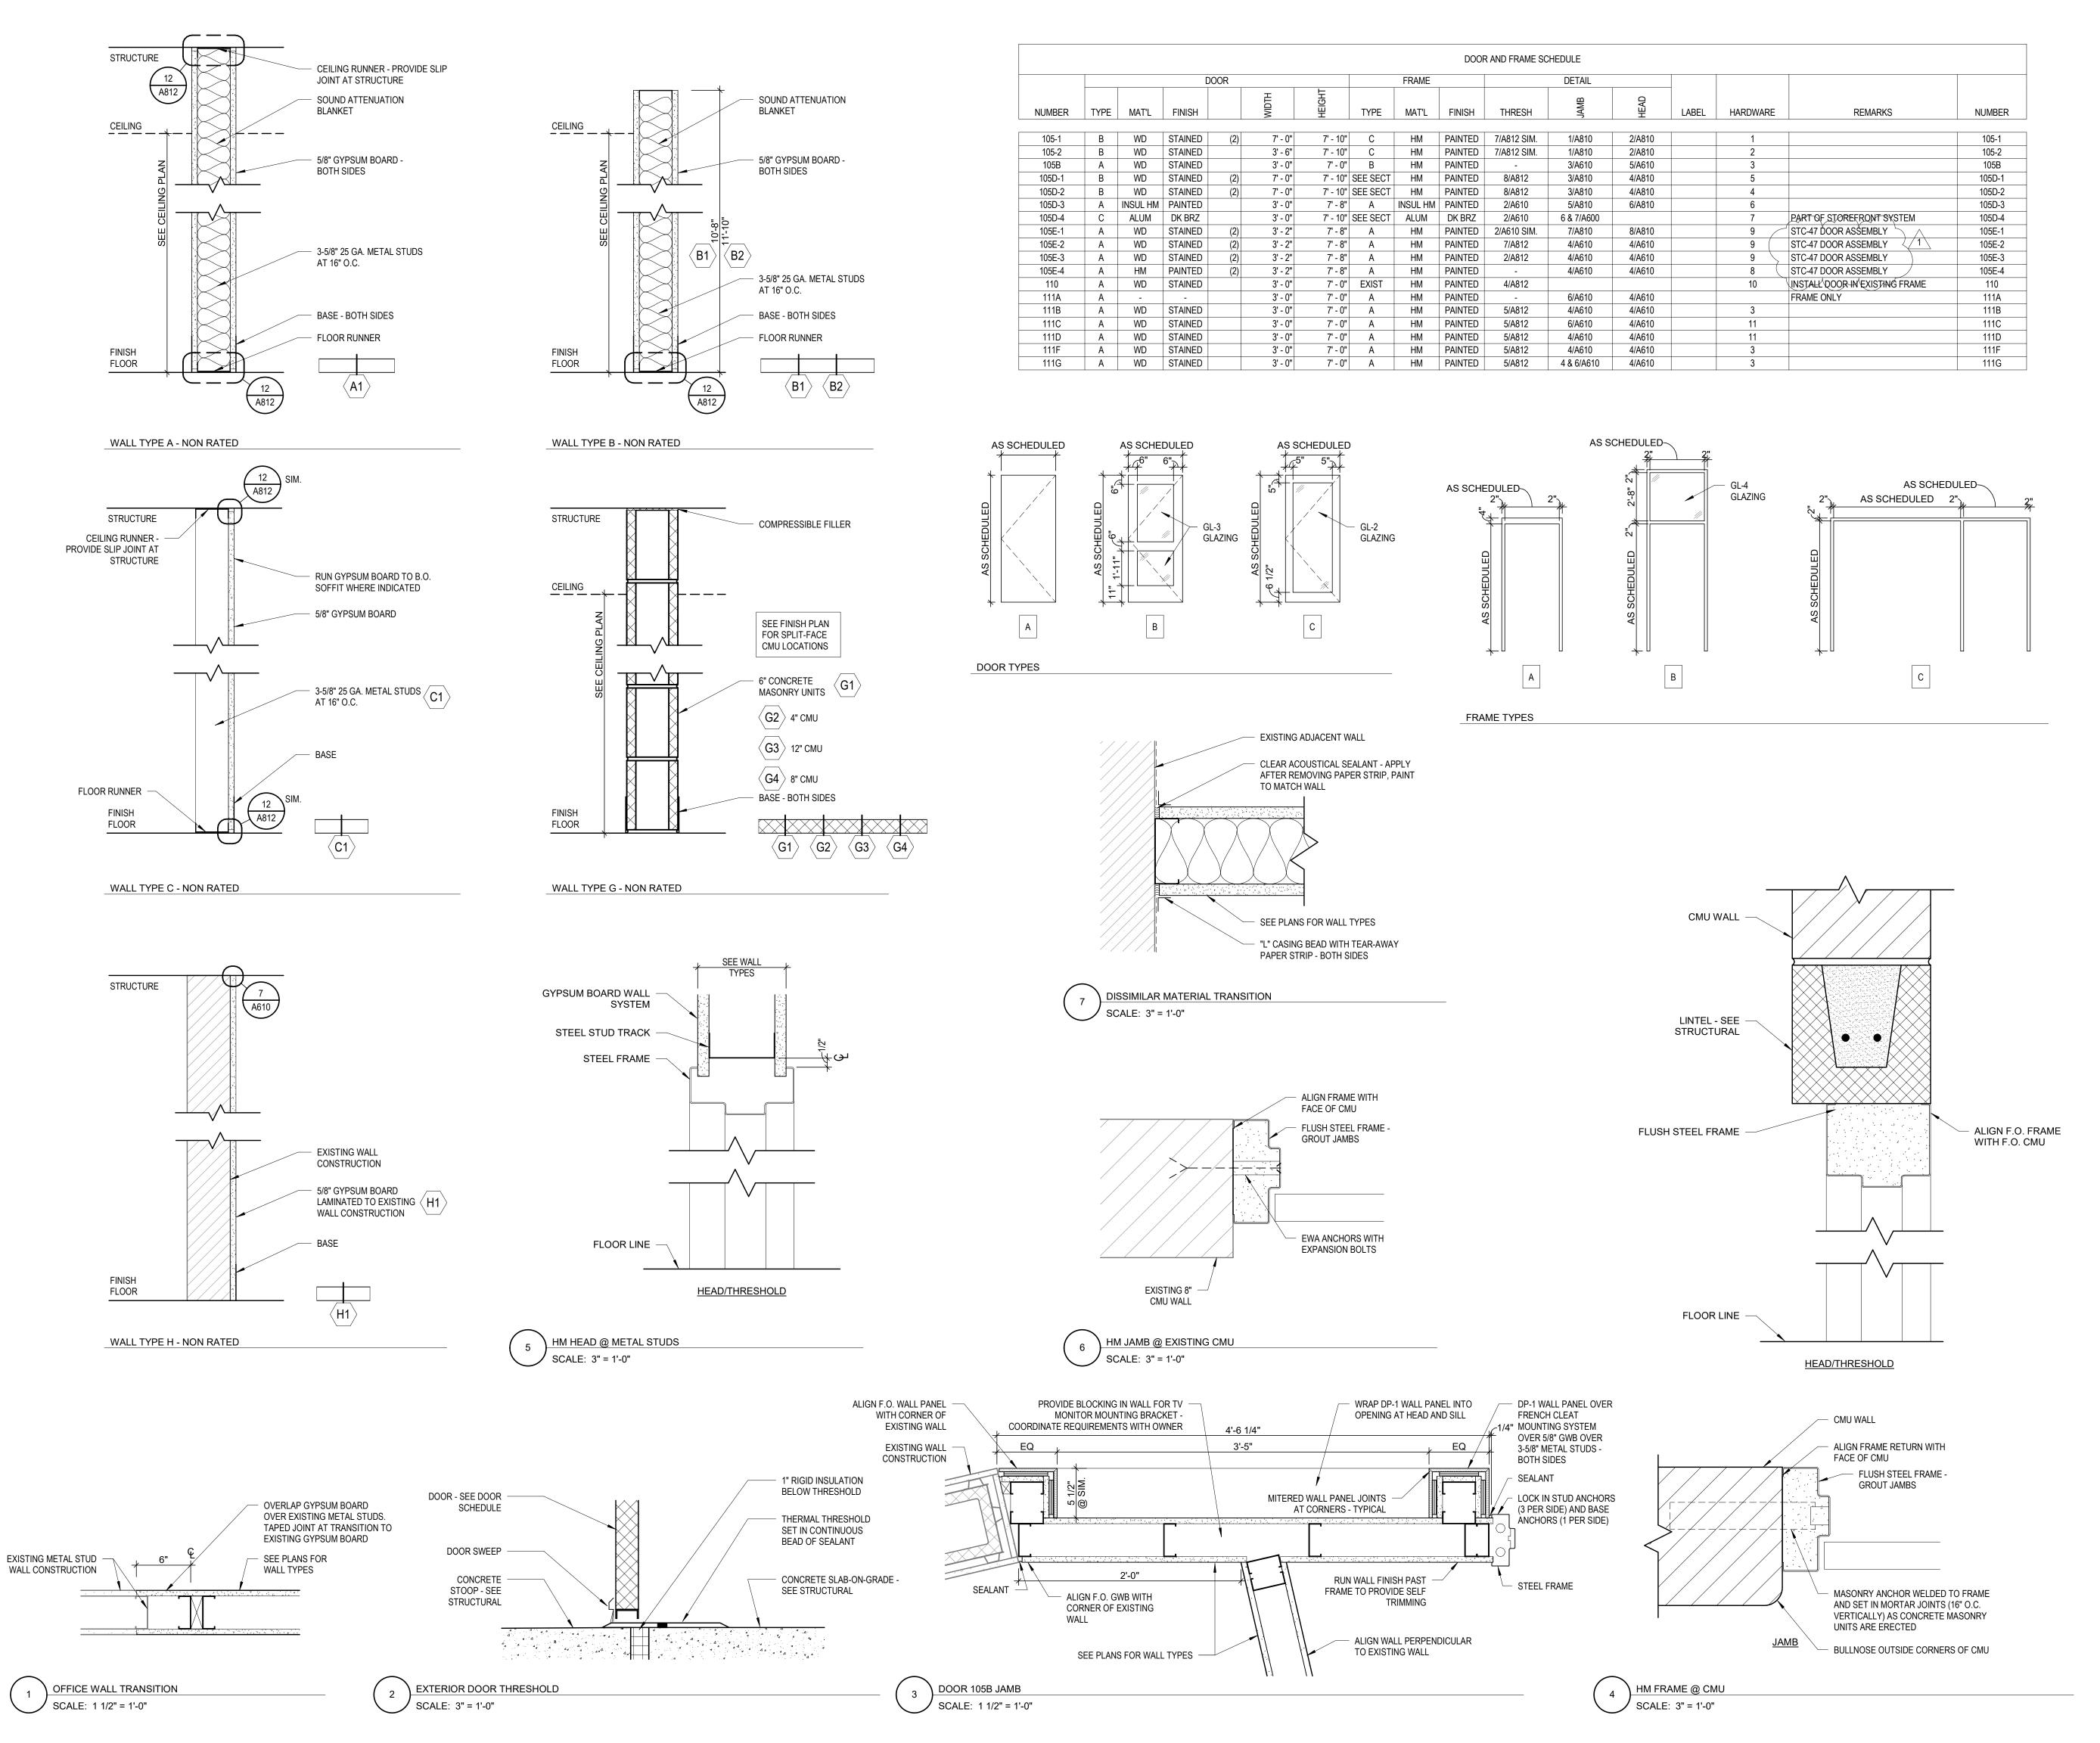



# WARNER PARK COMMUNITY RECREATION CENTER EXPANSION

1625 NORTHPORT DRIVE MADISON, WI 53704 CITY OF MADISON PARKS DIVISION

330 EAST LAKESIDE STREET

MADISON, WI 53715

PROJECT NUMBER 223471.00

ISSUED FOR:

BID SET 5/16/2024

REVISION FOR:

NO. DESCRIPTION DATE

1 ADDENDUM #2

6/13/2024

DRAWN BY DKB

DOOR SCHEDULE & WALL TYPES

CHECKED BY

A610

				F	FINISH SCHEDULE				
		FLOORS	BASE		WALL I	FINISH		CEILING	
				NORTH	EAST	SOUTH	WEST		
RM#	ROOM NAME	FINISH	FINISH	FINISH	FINISH	FINISH	FINISH	FINISH	REMARKS
102	EXERCISE	RF-1/RF-2	RB-1	PT-1/PT-2	PT-7	EX/PT-7	PT-5	OTS/EX	PAINT EXPOSED STRUCTURE AND UTILITIES TO MATCH EXISTING
103	OFFICE	RF-2	RB-1	PT-1	PT-1	PT-1	PT-1	OTS/EX	PAINT EXPOSED STRUCTURE AND UTILITIES TO MATCH EXISTING
105A	CORRIDOR	EX/CPT-3/CPT-4	SEE PLAN	EX/PT-4/DP-1	NA	PT-6/DP-1	NA	PLW/AP-1	
105B	COMFORT	CPT-3	RB-1	PT-1	PT-6	PT-1	PT-1	GWB/PT-10	
105C	PRE-FUNCTION	TZ-1/TZ-2/TZ-3	SEE PLAN	SEE PLAN	SEE PLAN	SEE PLAN	DP-1/PT-2/PT-6	OTS/PT-11	
105D	GYMNASIUM	RSF-1/RSF-2	RB-1	CMU-1	CMU-1	CMU-1	CMU-1	OTS/PT-11	PAINT HEADWALLS ABOVE STOREFROM TO MATCH METAL DECK
105E	STORAGE	SC-1	RB-1	PT-1	PT-1	PT-1	PT-1	OTS	
105F	MECHANICAL	SC-1	RB-1	PT-1	PT-1	PT-1	PT-1	OTS	
110	STORAGE	CPT-1	RB-1	PT-1	PT-1	PT-1	PT-1	GWB/PT-9	
111	CORRIDOR	CPT-1/CPT-2	RB-1	PT-2	PT-1	PT-3	PT-2	GWB/PT-10	
111A	LOCKER ROOM	CPT-1/CPT-2	CTB-1	PT-3/PT-1	PT-3/PT-1	PT-1	PT-1/PT-3/CT-4	GWB/PT-9	SEE ELEVATIONS
111B	SHOWER	CT-2	CTB-1	SS-1	SS-1/PT-1	PT-1	SS-1/PT-1	GWB/PT-9	SEE ELEVATIONS
111C	WOMENS	CT-1	CTB-1	CT-3	PT-1	CT-3/CT-4	CT-3	GWB/PT-9	SEE ELEVATIONS
111D	MENS	CT-1	CTB-1	CT-3/CT-4	PT-1	CT-3	CT-3	GWB/PT-9	SEE ELEVATIONS
111F	ADA TOILET	CT-1	CTB-1	PT-1	CT-3/CT-4	CT-3	PT-1	GWB/PT-9	SEE ELEVATIONS
111G	ADA TOILET	CT-1	CTB-1	PT-1	PT-1	CT-3	CT-3/CT-4	GWB/PT-9	SEE ELEVATIONS

ABBREVIATIONS - FINISH

CMU CMU CARPET TILE

PLYWOOD

CERAMIC TILE

GWB PAINTED GYP BOARD CEILING

OPEN TO STRUCTURE

RUBBER BASE / RESILIENT BASE

PLASTIC LAMINATE

RESILIENT FLOOR

SEALED CONCRETE SOLID SURFACE

RIGID WALL PROTECTION

EXISTING GLASS

METAL PANEL

DECORATIVE PANEL

RESILIENT SPORTS FLOOR

ACOUSTICAL CEILING TILE ACOUSTICAL PANEL

FINISH DESCRIPTION

FINISH TAG

CMU-1

CMU-2 CPT

DP

PLW

RSF

ACT

CT

EX

MP

OTS

PLAM

RWP


TAG	PRODUCT	MANUFACTURER	COLLECTION/STYLE	COLOR	FINISH	SIZE	NOTES
AD 4	A COLIOTIO DANIE!	A DICTI ID A	MADOD TDAIL	ADICTUDA MUNTE	NAATTE	0.411.37.4011	
AP-1	ACOUSTIC PANEL	ARKTURA	VAPOR TRAIL	ARKTURA WHITE	MATTE	24" X 48"	
CMU-1	CONCRETE MASONRY UNIT	COUNTY MATERIALS CORP.	SPLITFACE/SMOOTHFACE	SANDSTONE 18-314C	SMOOTH	8" X 16"	
CMU-2	CONCRETE MASONRY UNIT	COUNTY MATERIALS CORP.	PREMIER ULTRA BURNISHED	NORTH STAR 63-222B	SMOOTH	8" X 16"	
CPT-1	CARPET TILE	FORBO	FLOTEX/SEAGRASS	ALMOND 111003	STANDARD	9.5"X 39.4"	BRICK PATTERN INSTALLATION/50% OF COLOR MIX
CPT-2	CARPET TILE	FORBO	FLOTEX/SEAGRASS	CHARCOAL 111004	STANDARD	9.5"X 39.4"	BRICK PATTERN INSTALLATION/50% OF COLOR
CPT-3	CARPET TILE	FORBO	FLOTEX/SEAGRASS	WALNUT 111005	STANDARD	9.5"X 39.4"	BRICK PATTERN INSTALLATION
CPT-4	CARPET TILE	FORBO	FLOTEX/SEAGRASS	LIQUORICE 111006	STANDARD	9.5"X 39.4"	BRICK PATTERN INSTALLATION
CT-1	CERAMIC TILE	DALTILE	FABRIC ART/MODERN LINEAR	TAUPE ML62	MATTE	12" X 24"	
CT-2	CERAMIC TILE	DALTILE	FABRIC ART/MODERN TEXTILE	TAUPE MT52	MATTE	1" X 3" MOSAIC	
CT-3	CERAMIC TILE	DALTILE	FABRIQUE	BLANC LINEN P685	MATTE	12" X 24"	
CT-4	CERAMIC TILE	CAESAR CERAMICHE	COCOON/CADENCE TILE	GLEE	MATTE	8" X 48"	
CTB-1	CERAMIC TILE BASE	DALTILE	FABRIC ART/MODERN LINEAR	TAUPE ML62	MATTE	6" X 12"	
DP-1	DECORATIVE PANEL	ACROVYN	ACROVYN BY DESIGN METALLICS	MEDIUM BRONZE #18172	METALLIC		
PT-1	PAINT	BENJAMIN MOORE	WALL PAINT	CLOUD WHITE 967	SEMI-GLOSS	-	
PT-2	PAINT	BENJAMIN MOORE	ACCENT PAINT	EDGECOMB GRAY HC-173	SEMI-GLOSS	-	
PT-3	PAINT	SHERWIN WILLIAMS	ACCENT PAINT	REFUGE SW6228	SEMI-GLOSS	-	
PT-4	PAINT	SHERWIN WILLIAMS	ACCENT PAINT	CURIO GRAY SW0024	EGGSHELL	-	
PT-5	PAINT	SHERWIN WILLIAMS	ACCENT PAINT	STILL WATER SW6223	EGGSHELL	-	
PT-6	PAINT	SHERWIN WILLIAMS	ACCENT PAINT	INTERESTING AQUA SW6220	EGGSHELL	-	
PT-7	PAINT	BENJAMIN MOORE	ACCENT PAINT	GRENADA GREEN 432	EGGSHELL	-	
PT-8	PAINT	BENJAMIN MOORE	DOOR FRAME PAINT	DEVONSHIRE GREEN 1489	SEMI-GLOSS	-	
PT-9	PAINT	SHERWIN WILLIAMS	CEILING PAINT	HIGH REFLECTIVE WHITE SW7757	SEMI-GLOSS	-	
PT-10	PAINT	SHERWIN WILLIAMS	CEILING PAINT	HIGH REFLECTIVE WHITE SW7757	FLAT	-	
PT-11	PAINT	BENJAMIN MOORE	CEILING PAINT	DUNE WHITE 968	SEMI-GLOSS	-	
RB-1	RESILIENT BASE	TARKETT	THERMOSET RUBBER	BURNT UMBER 63	SOLID	4" HIGH	
RF-1	RESILIENT FLOOR	TARKETT SPORTS	DROPZONE ELITE	DARK GREY DZ502	STANDARD	48" W ROLL	
RF-2	RESILIENT FLOOR	TARKETT SPORTS	DROPZONE ELITE	MED GREY DZ504	STANDARD	48" W ROLL	
RSF-1	RESILIENT SPORTS FLOOR	TARKETT SPORTS	OMNISPORTS HPL7	GOLDEN MAPLE	STANDARD	66" W ROLL	CLASS 1 SYSTEM
RSF-2	RESILIENT SPORTS FLOOR	TARKETT SPORTS	OMNISPORTS ACTIVE+	GOLDEN MAPLE	STANDARD	66" W ROLL	CLASS 3 SYSTEM
SC-1	SEALED CONCRETE	-	-	-	-	-	
SS-1	SOLID SURFACE	FORMICA	EVERFORM SOLID SURFACE	FROST 103	MATTE	SEE DETAILS	
SS-2	SOLID SURFACE	FORMICA	EVERFORM SOLID SURFACE	WHITE SPEX 931	MATTE	SEE DETAILS	
TZ-1	TERRAZZO	WISCONSIN TERRAZZO	RESINOUS MIX	WISCONSIN TERRAZZO #3591-E	POLISHED	CUSTOM	
TZ-2	TERRAZZO	WISCONSIN TERRAZZO	RESINOUS MIX	WISCONSIN TERRAZZO #3590-E	POLISHED	CUSTOM	
TZ-3	TERRAZZO	WISCONSIN TERRAZZO	RESINOUS MIX	WISCONSIN TERRAZZO #3605-E	POLISHED	CUSTOM	

**FINISH KEY** 

CPT-3 FLOOR F	INISH
CPT-4 FLOOR F	
	INISH
TZ-1 FLOOR FIN	IISH
TZ-2 FLOOR FIN	IISH
TZ-3 FLOOR FIN	IISH

5. TILE FLOORS TO RECEIVE TILE BASE. GYPSUM BOARD, PLYWOOD, DECORATIVE PANEL, AND SMOOTH-FACE CMU WALLS TO RECEIVE RESILIENT BASE. SPLIT-FACE MASONRY WALLS TO RECEIVE NO

6. SEE DOOR SCHEDULE FOR ADDITIONAL INFORMATION ON

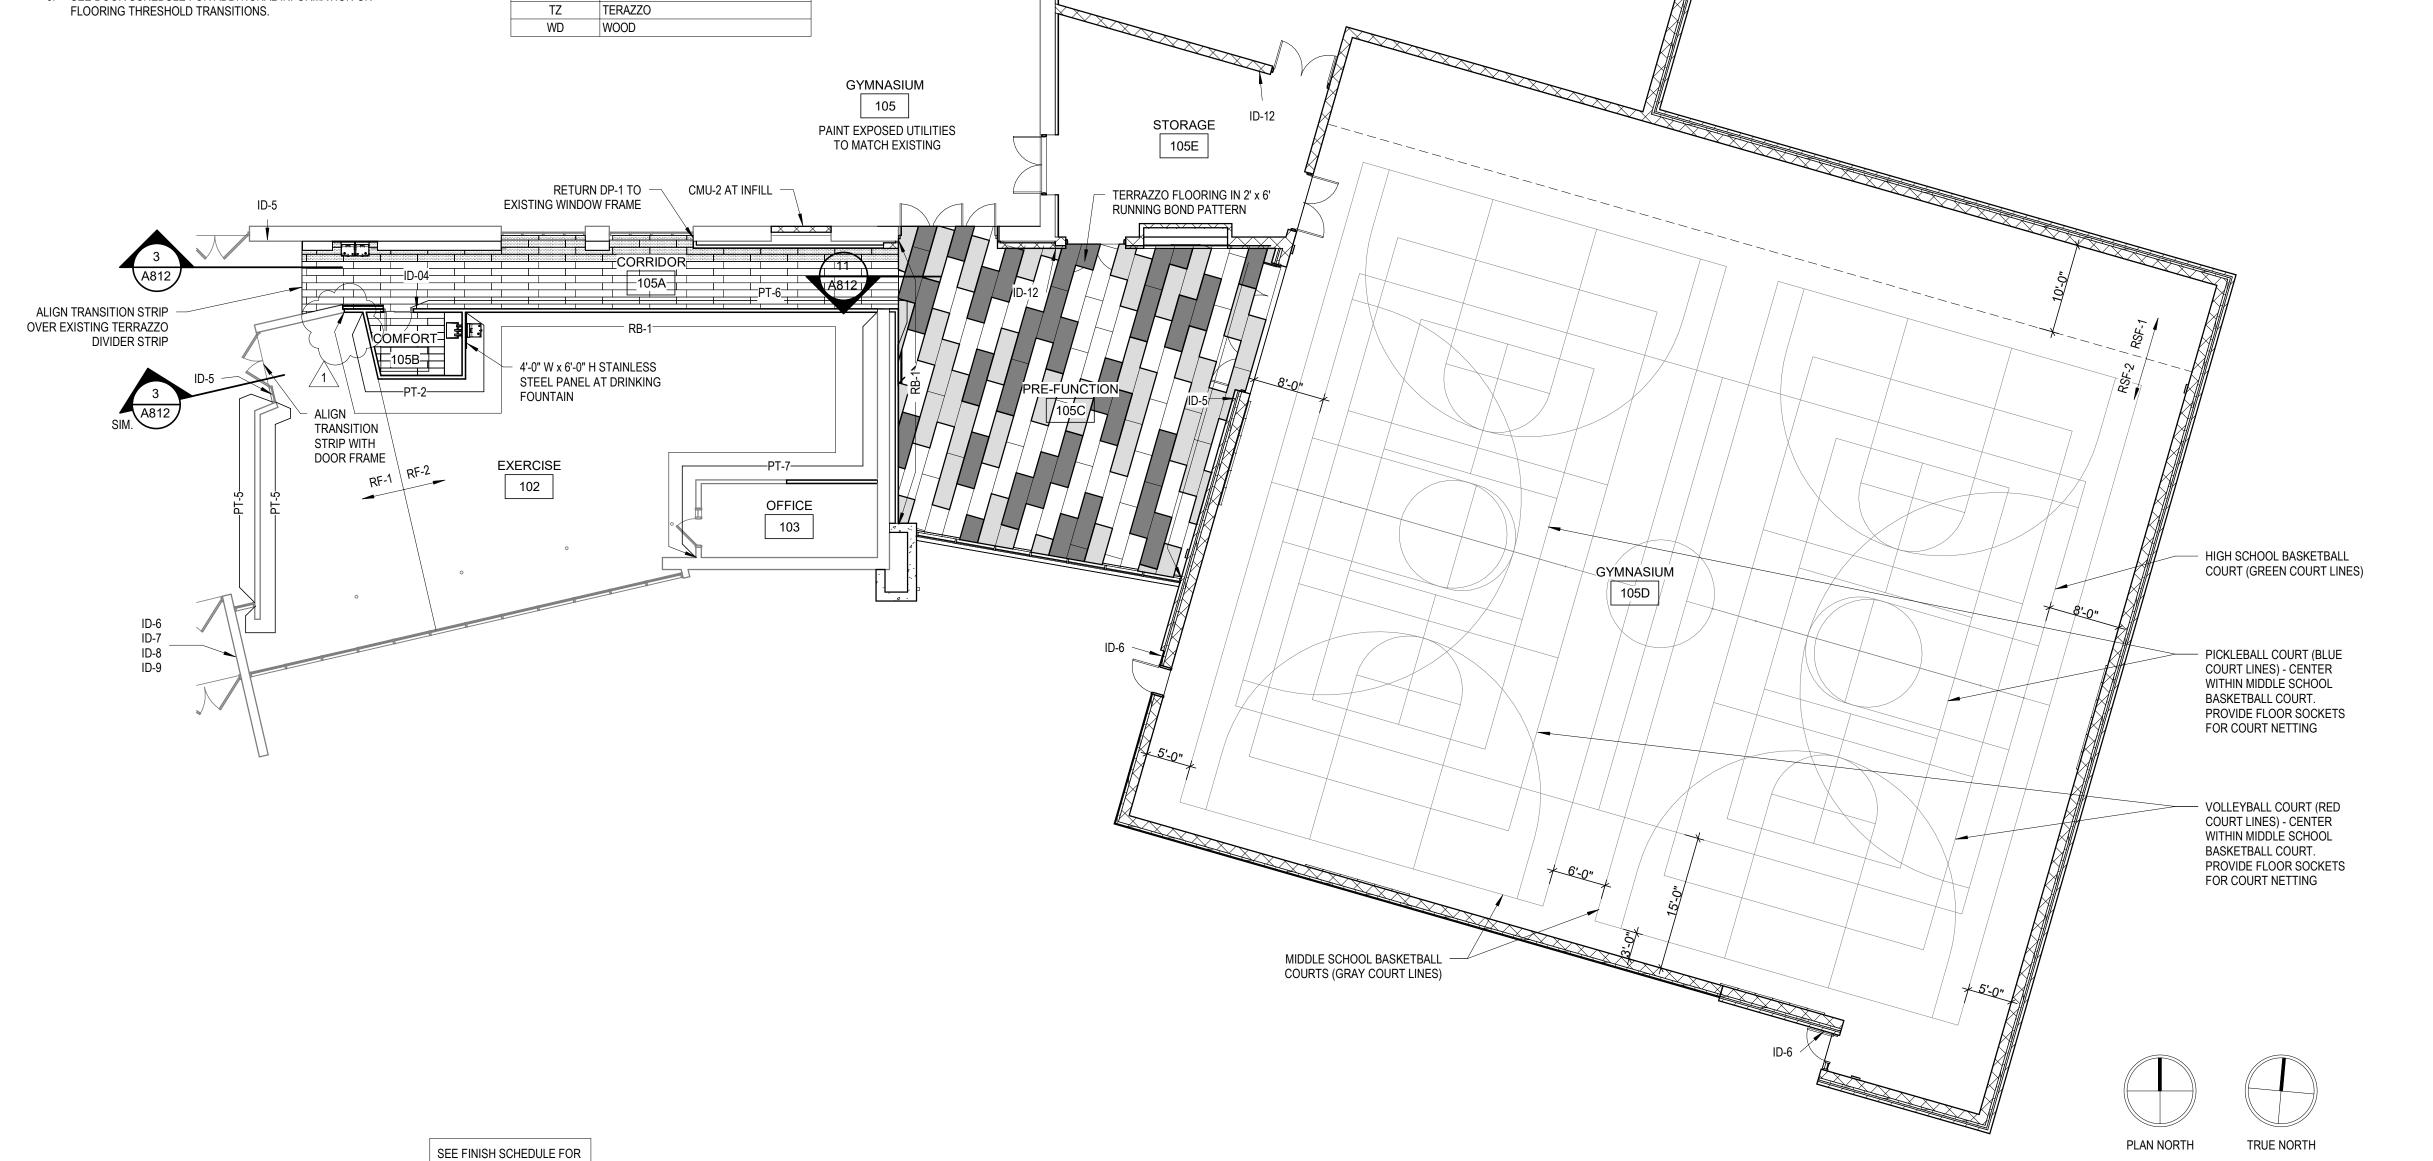

MECHANICAL

105F



MILWAUKEE | MADISON | CHICAGO

# WARNER PARK COMMUNITY RECREATION **CENTER EXPANSION**

223471.00

1625 NORTHPORT DRIVE MADISON, WI 53704 CITY OF MADISON PARKS DIVISION 330 EAST LAKESIDE STREET

PROJECT NUMBER

MADISON, WI 53715

ISSUED FOR: 5/16/2024 **BID SET** REVISION FOR: NO. DESCRIPTION DATE 6/13/2024 1 ADDENDUM #2


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FINISH PLANS & SCHEDULE

**A700** 

**EXPANSION FINISH PLAN** SCALE: 3/32" = 1'-0"

ADDITIONAL INFORMATION



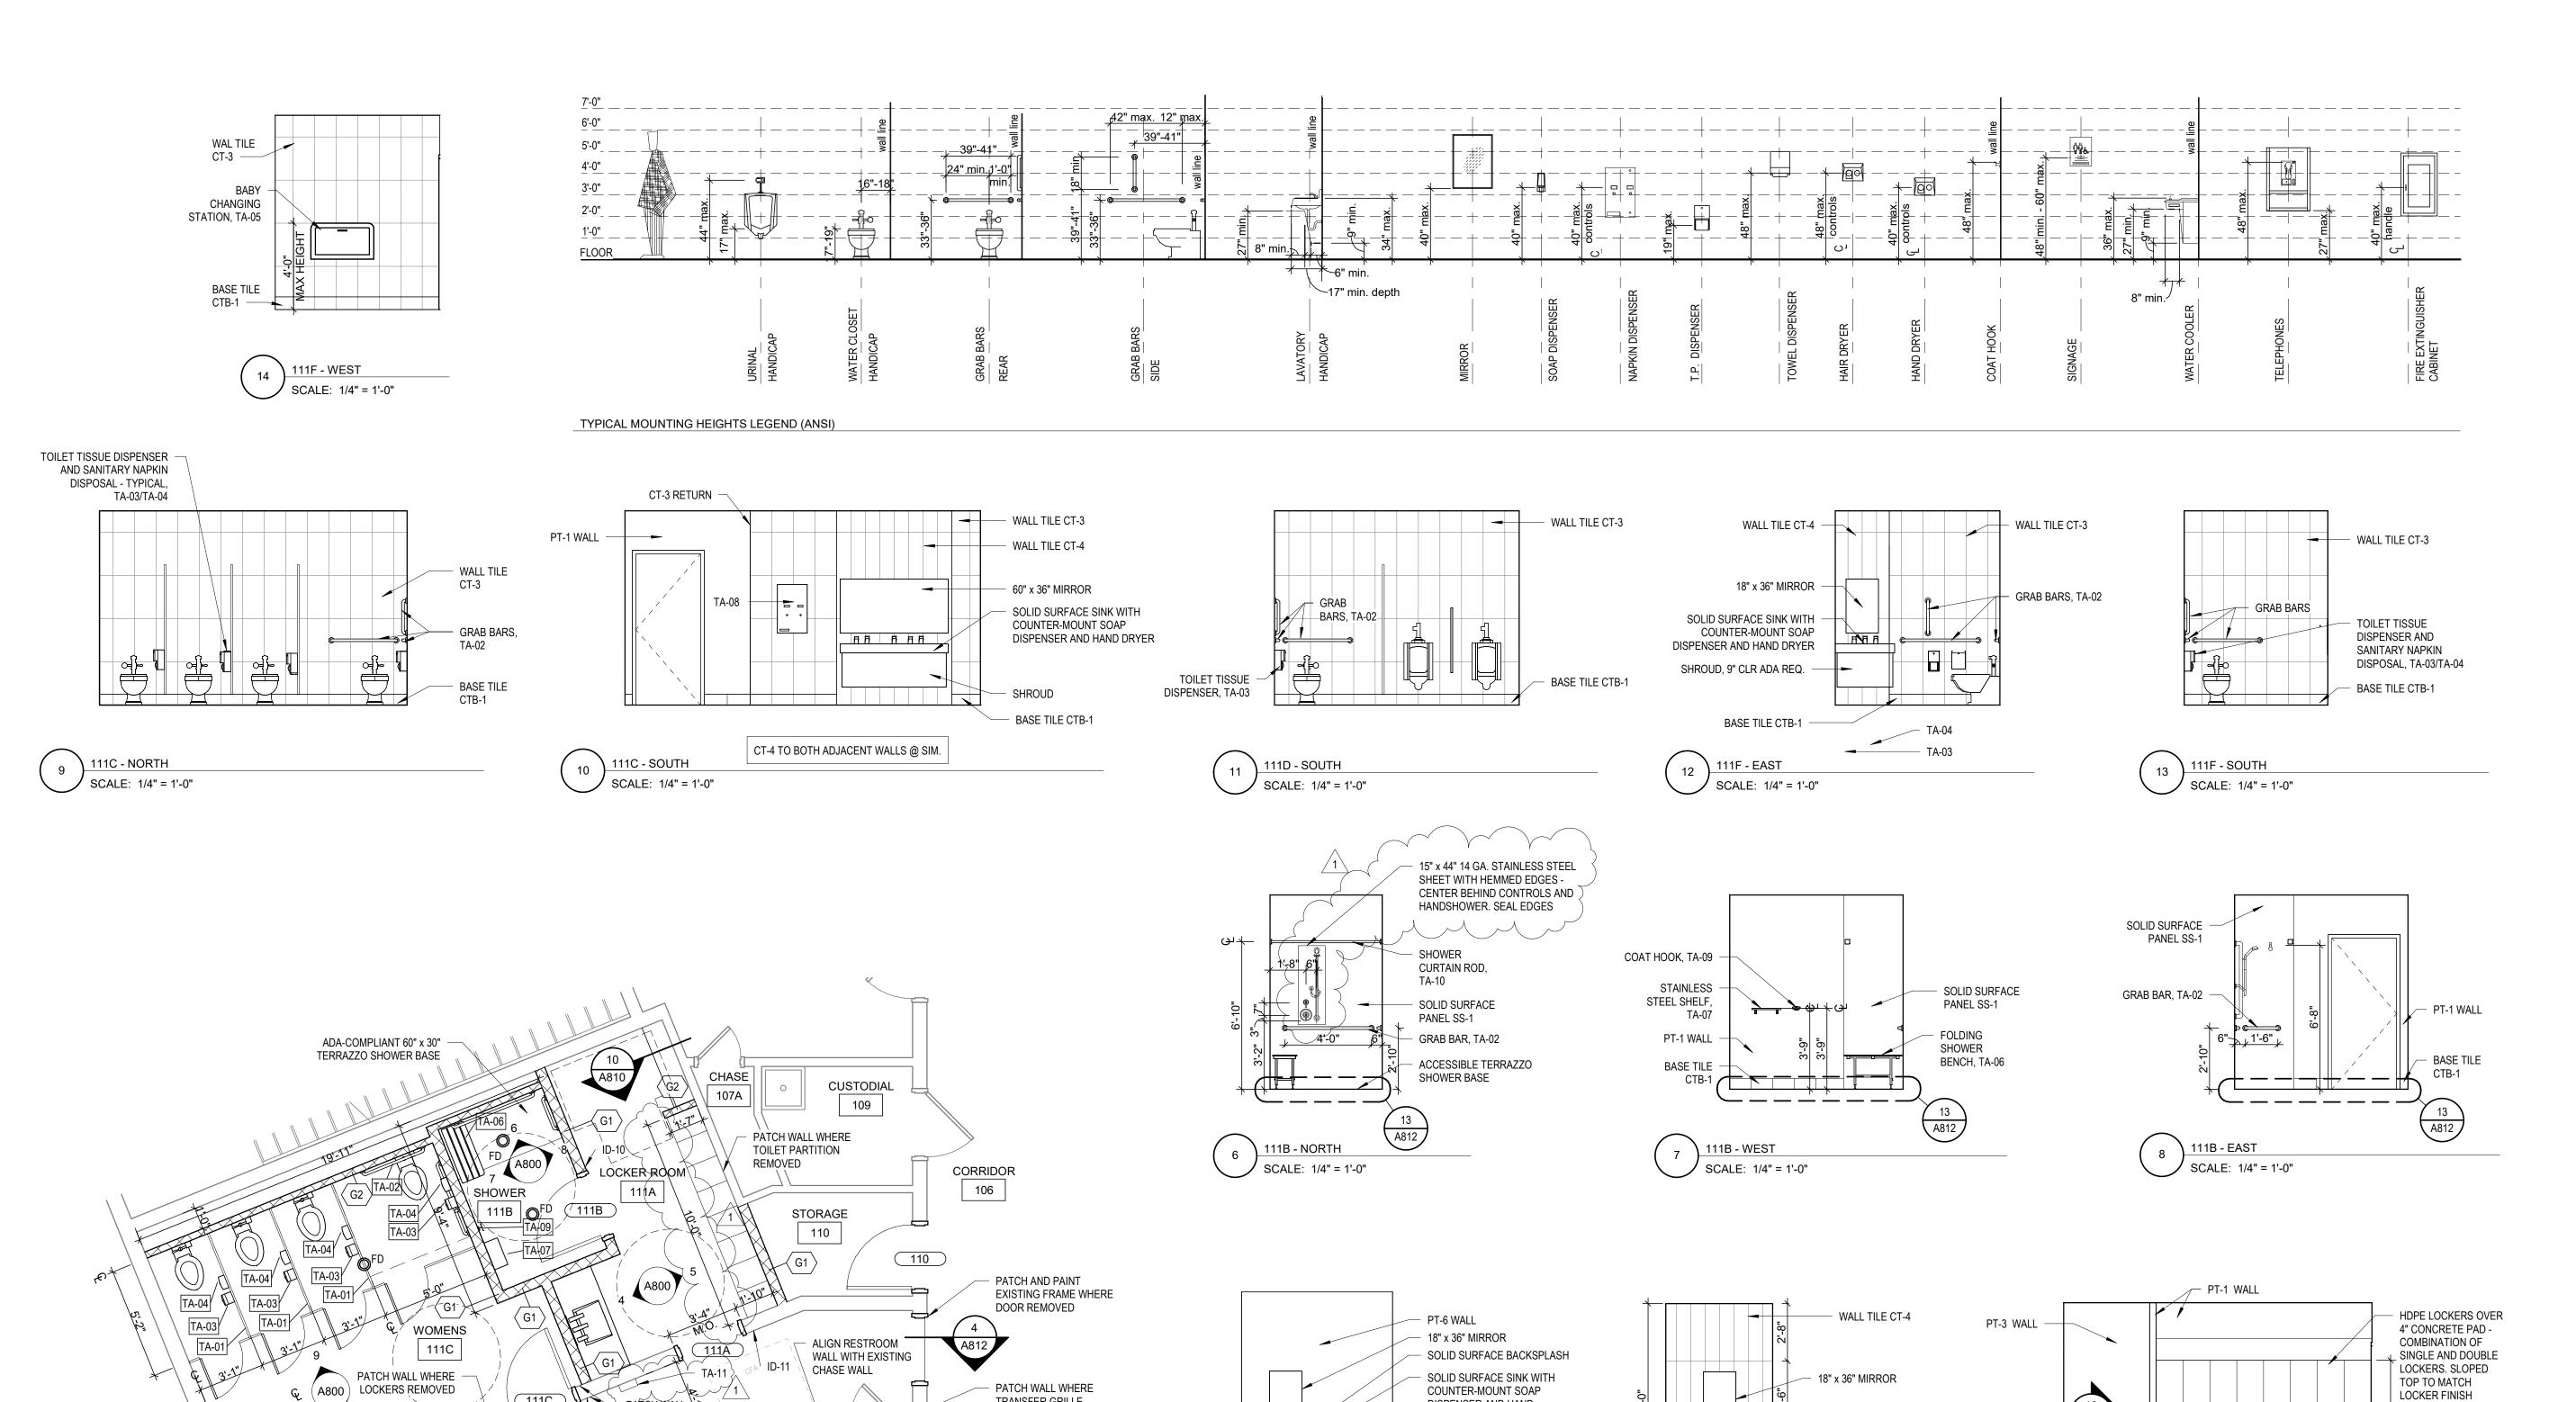

# WARNER PARK COMMUNITY RECREATION CENTER EXPANSION

223471.00

1625 NORTHPORT DRIVE MADISON, WI 53704

CITY OF MADISON PARKS DIVISION 330 EAST LAKESIDE STREET

PROJECT NUMBER

MADISON, WI 53715

ISSUED FOR: 5/16/2024 BID SET **REVISION FOR:** NO. DESCRIPTION DATE 6/13/2024 1 ADDENDUM #2

DRAWN BY CHECKED BY

**ENLARGED PLANS &** 

INTERIOR ELEVATIONS

HAND DRYER SOAP DISPENSER SOAP DISPENSER SOAP DISPENSER FAUCET FAUCET SOAP DISPENSER FAUCET FAUCET SOAP DISPENSER - FAUCET HAND DRYER HAND DRYER HAND DRYER 1'-0" 6" 6" 6" 6" ROOM 111C AND 111D ROOM 111F AND 111G <u>ROOM 111A</u> ROOM 111C AND 111D SEE PLUMBING FOR ADDITIONAL INFORMATION

SOLID SURFACE SINK WITH

DRYER - CENTER IN ALCOVE

COUNTER-MOUNT SOAP

DISPENSER AND HAND

METALSHROUD

R R R

111A - WEST

SCALE: 1/4" = 1'-0"

A810

/ SCALE: 1/4" = 1'-0"

RB-1 - TYPICAL

ENLARGED PLAN - RESTROOMS SCALE: 1/4" = 1'-0"

SOLID SURFACE CONTINUOUS -TROUGH SINKS WITH COUNTER-MOUNTED FAUCET,

SOAP DISPENSER, AND HAND

DRYER - TYPICAL

SINK DETAILS SCALE: 3/8" = 1'-0"

105B - EAST

SCALE: 1/4" = 1'-0"

DISPENSER AND HAND

FOR LENGTH OF WALL

METAL SHROUD

DRYER - EXTEND COUNTER

TRANSFER GRILLE REMOVED (2 LOCATIONS)

EXISTING EWC

PATCH WALL WHERE

PLUMBING FIXTURES AND TOILET PARTITION

TO REMAIN

REMOVED

CHASE

ADA TOILET

PATCH SLAB-ON-GRADE WHERE CUT FOR PLUMBING TIE-INS -

DEPRESS SLAB 2" IN SHOWER ROOM

PATCH WALL
WHERE WALL
REMOVED

111

111D

₹10 OPP.

**A800** 



# WARNER PARK COMMUNITY RECREATION CENTER EXPANSION

1625 NORTHPORT DRIVE MADISON, WI 53704 CITY OF MADISON PARKS DIVISION 330 EAST LAKESIDE STREET

PROJECT NUMBER

MADISON, WI 53715

223471.00

DATE

6/13/2024

ISSUED FOR:

BID SET 5/16/2024

REVISION FOR:


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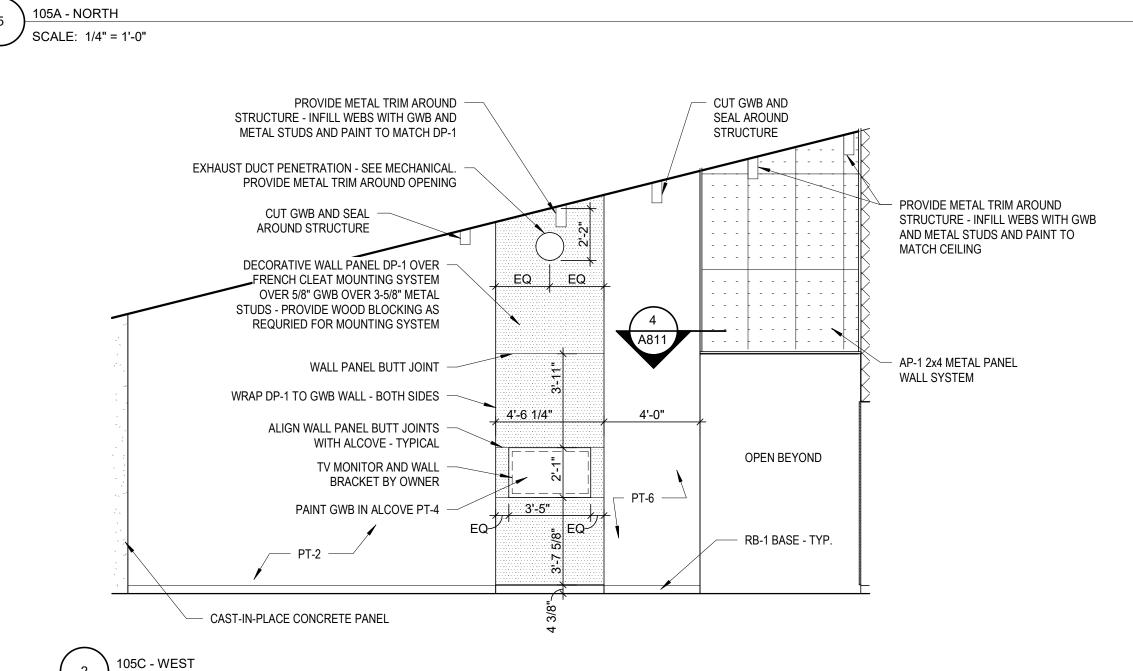
1 ADDENDUM #2


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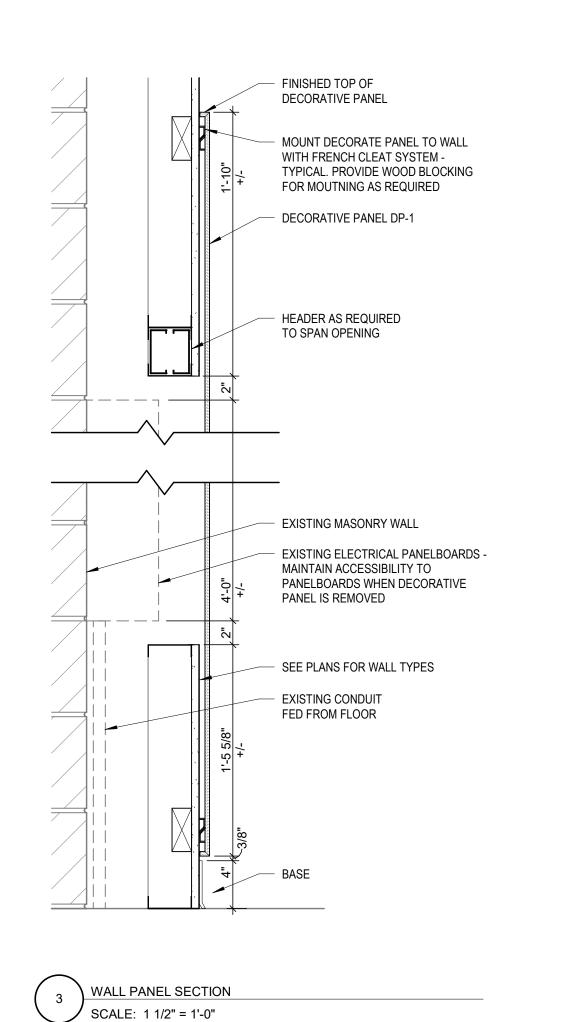
INTERIOR ELEVATIONS


**A801** 






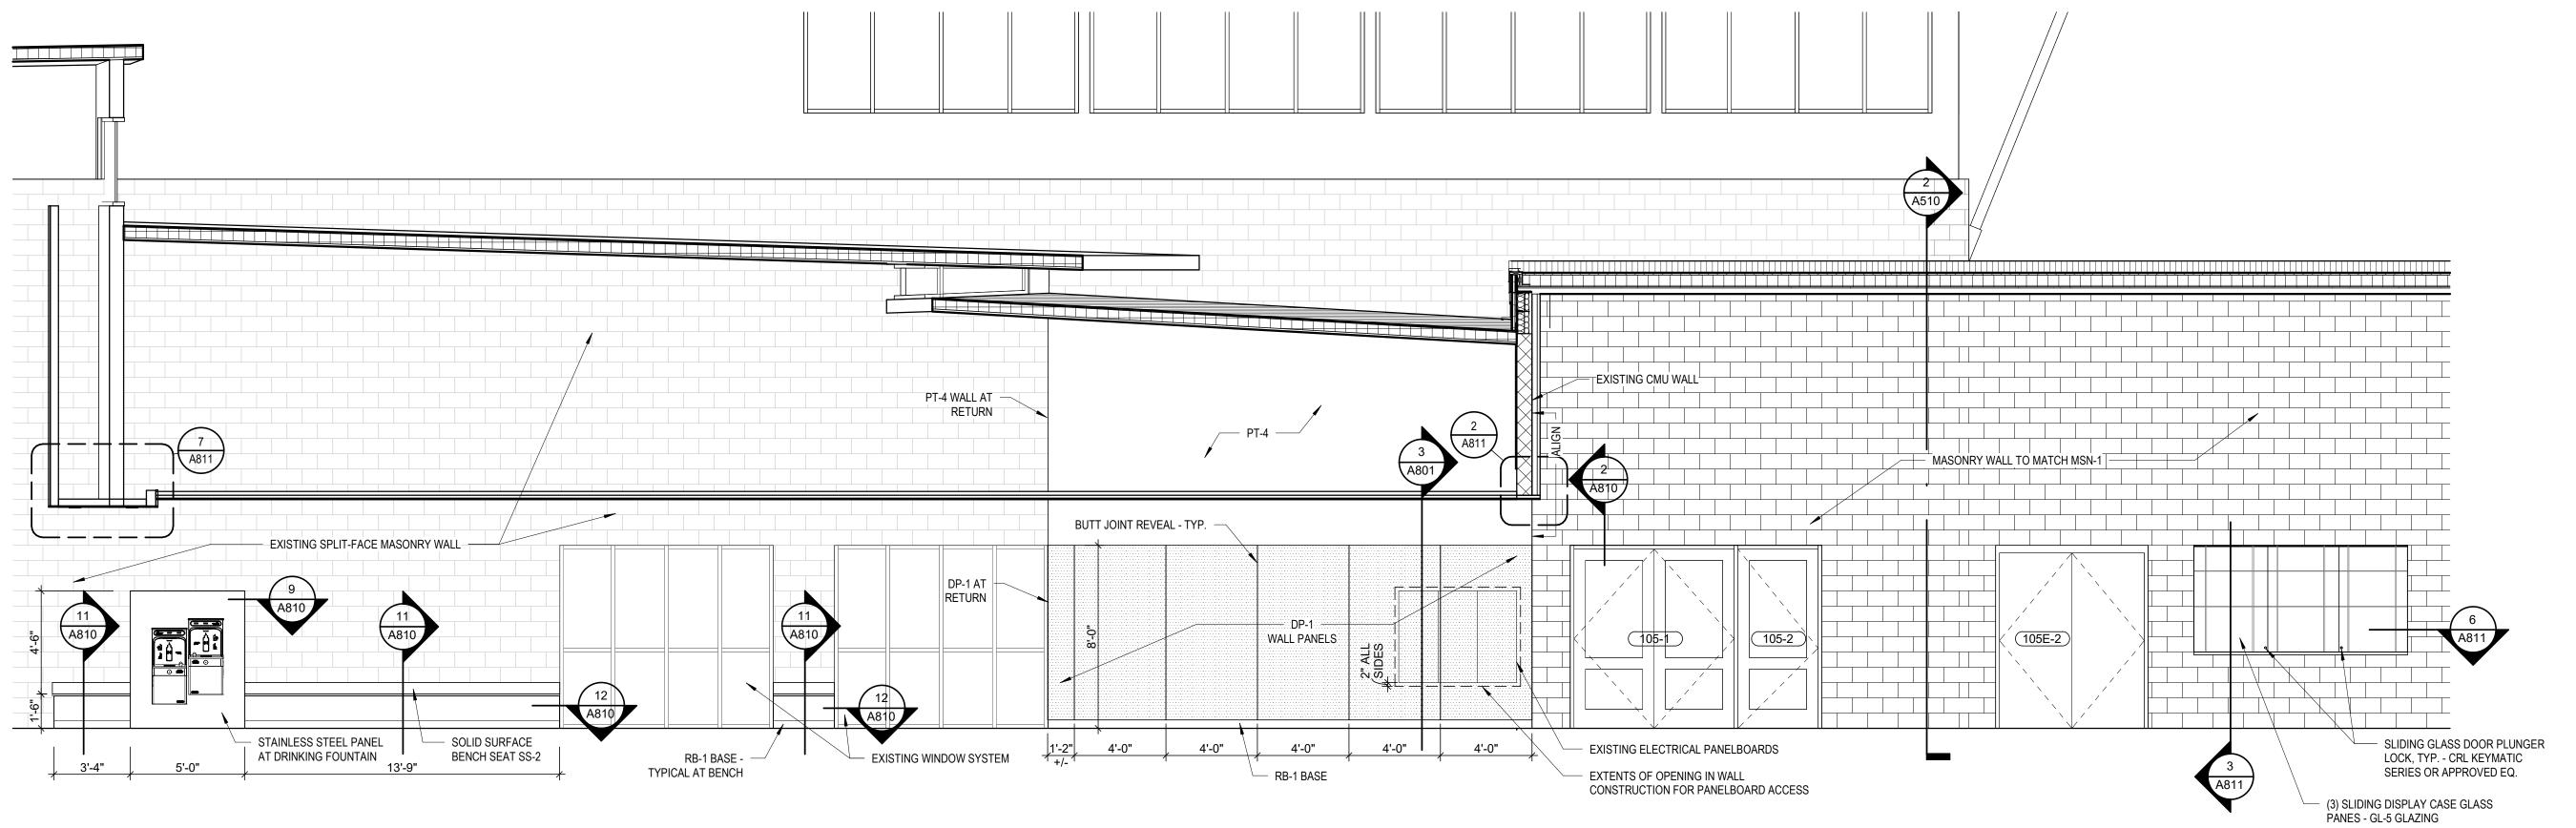

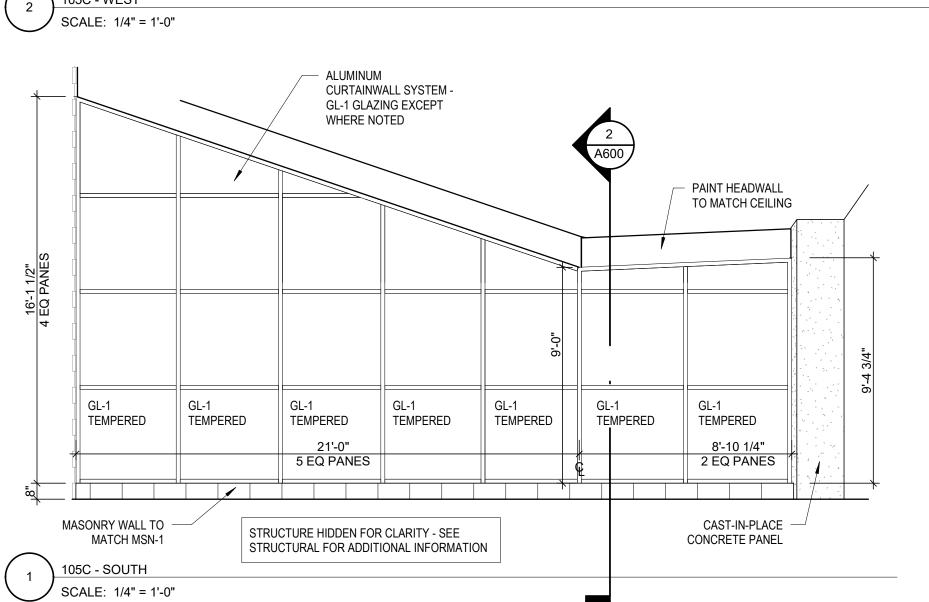

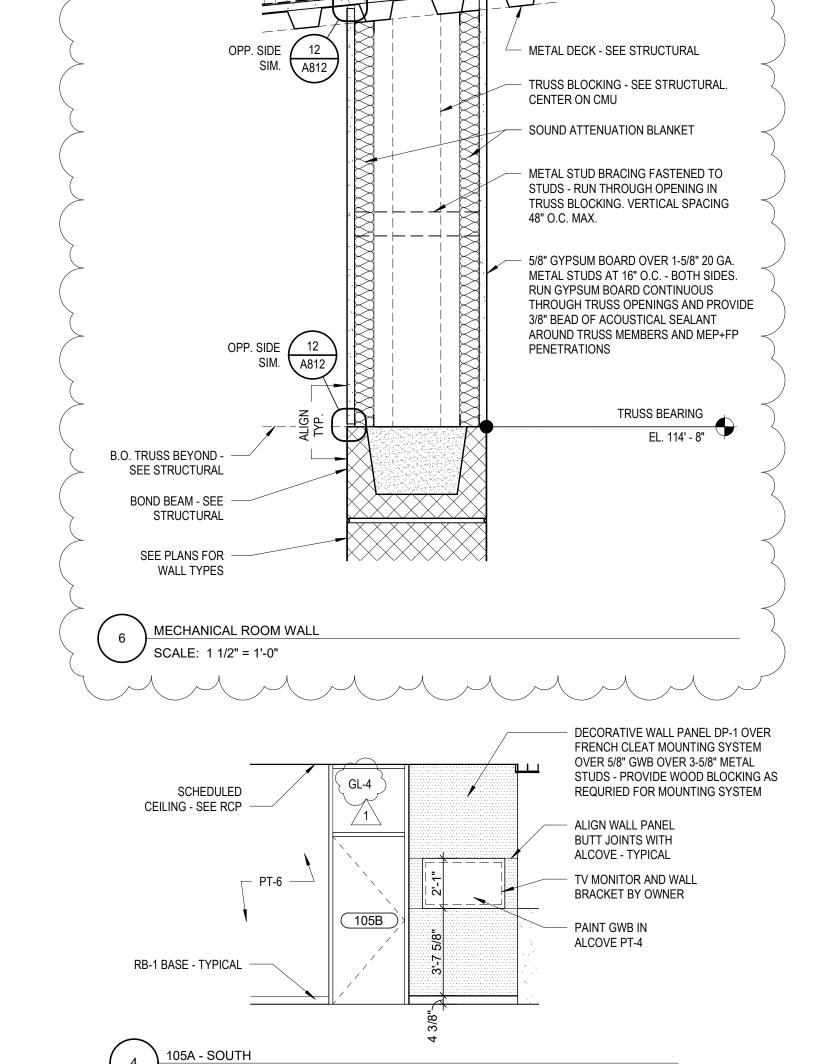

/ SCALE: 1/4" = 1'-0"

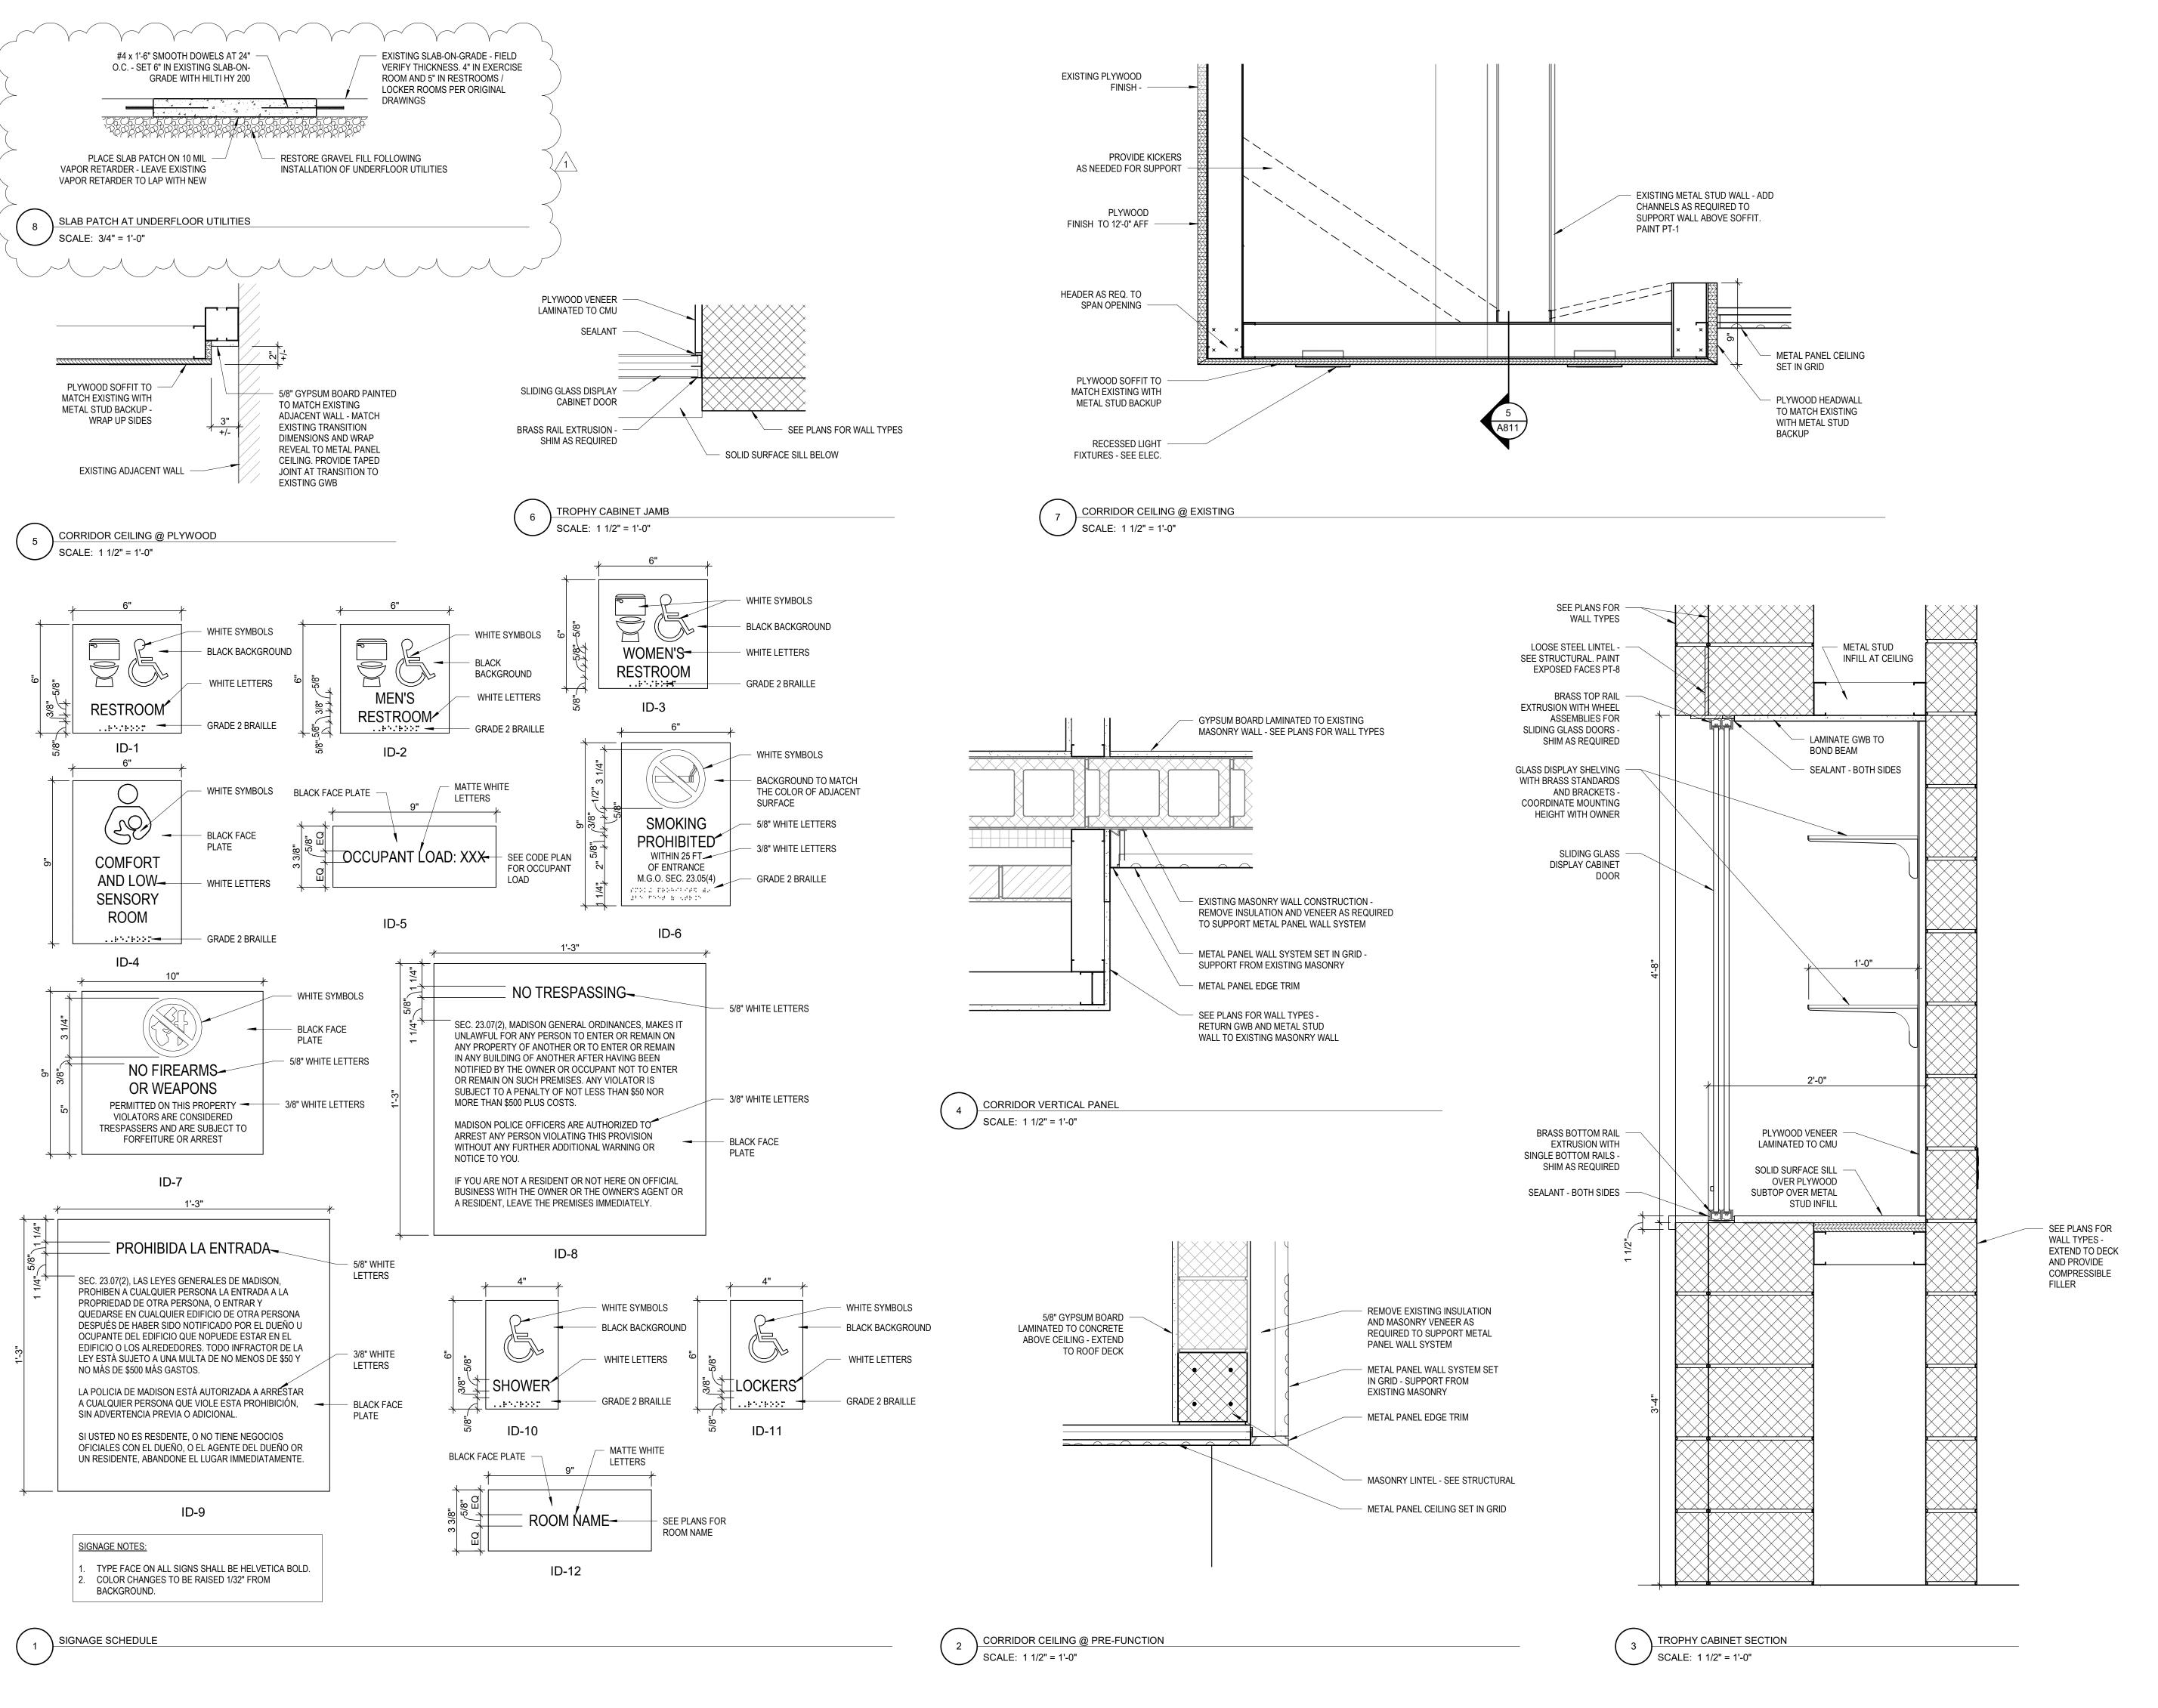



# WARNER PARK COMMUNITY RECREATION CENTER EXPANSION

1625 NORTHPORT DRIVE MADISON, WI 53704 CITY OF MADISON PARKS DIVISION 330 EAST LAKESIDE STREET

PROJECT NUMBER

MADISON, WI 53715

NUMBER

223471.00

ISSUED FOR:

BID SET 5/16/2024

REVISION FOR:

NO. DESCRIPTION1 ADDENDUM #2

DATE 6/13/2024

DRAWN BY

CHECKED BY

INTERIOR DETAILS


**A811** 

## STRUCTURAL DESIGN CRITERIA

 THESE NOTES SUPPLEMENT THE SPECIFICATIONS. PROJECT SPECIFICATIONS SHALL BE REFERRED TO FOR CLARIFICATIONS AND ADDITIONAL INFORMATION. IN CASE OF CONFLICT BETWEEN PROJECT SPECIFICATIONS AND THESE NOTES, THESE NOTES SHALL GOVERN.

2. GOVERNING BUILDING CODE: 2015 IBC AS AMENDED BY THE STATE OF WISCONSIN.

#### 3. DESIGN LOADS

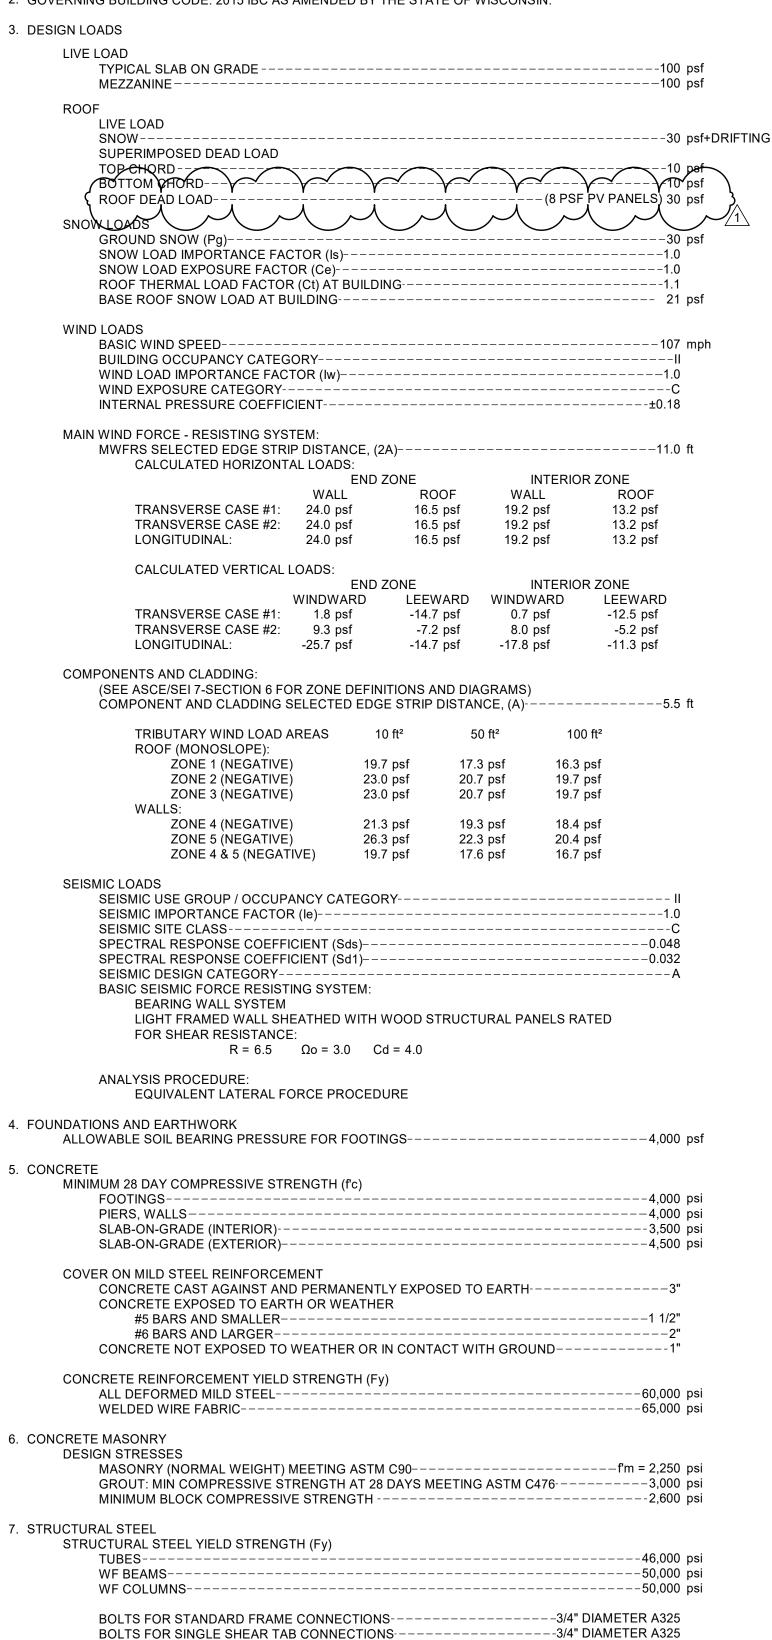

# 8. MISCELLANEOUS

VERIFY OPENINGS THROUGH FLOOR AND WALLS WITH ARCHITECTURAL, MECHANICAL, PLUMBING, AND ELECTRICAL REQUIREMENTS. CHANGES IN SIZE, LOCATION OR NUMBER OF OPENINGS SHOWN ON THE STRUCTURAL DRAWINGS SHALL NOT BE PERMITTED WITHOUT WRITTEN APPROVAL OF THE STRUCTURAL ENGINEER. NOT ALL OPENINGS ARE SHOWN ON THE STRUCTURAL DRAWINGS.

ANCHOR RODS------F1554

WELDING ELECTRODES-----E70

## GENERAL NOTES APPLY TO ALL SHEETS

- 1.  $\,$  CONTRACTOR TO PROVIDE DRAFT STOPPING IN ATTIC. MAXIMUM AREA OF SUBDIVIDE ATTIC AREA IS 3000 SF CONTRACTOR TO COORDINATE LOCATION OF DRAFT STOPPING WITH ARCHITECT AND TRUSS SHOP DRAWINGS PRIOR TO START OF CONSTRUCTION. PROVIDE AN ATTIC ACCESS PANEL INTO EACH ATTIC COMPARTMENT. MINIMUM OPENING SIZE OF 20" x 30" COORDINATE LOCATION WITH ARCHITECT. DRAFT STOPPING TO EXTEND TO FASCIA AT OVERHANGS.
- 2. SECURE TRUSSES AT EACH BEARING WITH SIMPSON H2.5A MIN.
- 3. CONTRACTOR TO SUBMIT TRUSS SHOP DRAWINGS TO ARCHITECT FOR REVIEW PRIOR TO CONSTRUCTION.

### **GENERAL**

- I. STRUCTURAL DRAWINGS ARE INTENDED TO BE USED WITH ARCHITECTURAL AND MECHANICAL DRAWINGS CONTRACTOR IS RESPONSIBLE FOR COORDINATING SUCH REQUIREMENTS INTO THE SHOP DRAWINGS AND
- 2. NO OPENING SHALL BE MADE IN ANY STRUCTURAL BEAM, COLUMN, SUPPORT FLOOR, LOAD BEARING WALL, FOOTING, OR FOUNDATION WALL WITHOUT THE WRITTEN APPROVAL OF THE ARCHITECT/ ENGINEER. OPENINGS IN NON-LOAD BEARING WALLS REQUIRE THE ARCHITECT'S APPROVAL.
- 3. THE CONTRACTOR IS RESPONSIBLE FOR LIMITING THE AMOUNT OF CONSTRUCTION LOAD IMPOSED UPON NEW STRUCTURAL FRAMING. CONSTRUCTION LOADS SHALL NOT EXCEED THE DESIGN CAPACITY OF THE FRAMING AT THE TIME THE LOADS ARE IMPOSED.
- 4. THE STRUCTURE IS DESIGNED TO FUNCTION AS A UNIT UPON COMPLETION. THE CONTRACTOR IS RESPONSIBLE FOR FURNISHING ALL TEMPORARY BRACING AND/OR SUPPORT THAT MAY BE REQUIRED AS THE RESULT OF THE CONTRACTOR'S CONSTRUCTION METHODS AND/OR SEQUENCES. THE STRUCTURAL ENGINEER ASSUMES NO LIABILITY FOR THE STRUCTURE DURING CONSTRUCTION.
- FIREPROOFING METHODS AND MATERIALS FOR STRUCTURAL DRAWINGS. REFER TO ARCHITECTURAL DRAWINGS AND SPECIFICATIONS FOR RATING REQUIREMENTS, FIREPROOFING METHODS AND MATERIALS.
- ALL SECTIONS, DETAIL AND NOTES SHOWN ON THE STRUCTURAL DRAWINGS ARE INTENDED TO BE TYPICAL AND SHALL APPLY TO SIMILAR SITUATIONS ELSEWHERE UNLESS OTHERWISE NOTED.
- 7. WHEN CONFLICTS ARE NOTED ON THE DRAWINGS, THE CONTRACTOR IS RESPONSIBLE FOR NOTIFYING THE A/E FOR RESOLUTION PRIOR TO FABRICATION OR INSTALLATION.

# **FOUNDATION NOTES**

- 1. GEOTECHNICAL INFORMATION TAKEN FROM: GEOTECHNICAL EXPLORATION REPORT C23051-6.
- 2. THE OWNER SHALL RETAIN A SOILS ENGINEERING FIRM TO MONITOR PROPER SUBGRADE PREPARATIONS AND TO OVERSEE THE TESTING AND COMPACTION OF COMPACTED FILL MATERIAL
- 3. CONTRACTOR SHALL LOCATE EXISTING UNDERGROUND UTILITIES BEFORE FOUNDATION EXCAVATION IF UNDERGROUND UTILITY CONFLICTS ARE DISCOVERED BEFORE OR ENCOUNTERED DURING EXCAVATION, NOTIFY THE ARCHITECT/ENGINEER IMMEDIATELY.
- 4. CONTRACTOR SHALL VERIFY THE LOCATION AND ELEVATION OF ANY EXISTING FOUNDATIONS.
- 5. BEFORE PLACING FOOTINGS, FOUNDATIONS, GRADE BEAMS, OR SLAB-ON-GRADE, THE SUB-GRADE SHALL BE PREPARED AND INSPECTED AS REQUIRED BY THE SPECIFICATIONS AND THE DRAWINGS.
- 6. REINFORCE ALL FOUNDATION WALLS AND FOOTINGS AS SHOWN ON THE ARCHITECTURAL AND STRUCTURAL
- 7. CONTROL JOINTS IN THE CAST-IN-PLACE CONCRETE FOUNDATION WALLS SHALL BE PLACED AT NOT TO EXCEED 20' OC OR AS LOCATED ON THE DRAWINGS.
- 8. PERIMETER FOUNDATION WALL INSULATION IS NOT SHOWN ON THE FOUNDATION DETAILS. SEE ARCHITECTURAL DRAWINGS AND THE SPECIFICATIONS FOR INSULATION REQUIREMENTS.
- 9. SEE SPECIFICATIONS FOR FREE DRAINING BACKFILL BENEATH ALL CONCRETE WALKS AND SLABS ADJACENT TO
- 10. CONTRACTOR NOTE: THE BASE OF ALL EXCAVATIONS SHALL BE KEPT FREE OF WATER AND LOOSE SOIL PRIOR TO PLACING CONCRETE. CARE SHOULD BE TAKEN DURING EXCAVATION AND CONSTRUCTION TO MINIMIZE DISTURBANCE OF THE BEARING SOILS. THE CONCRETE SHOULD BE PLACED AS SOON AS POSSIBLE AFTER EXCAVATION TO PREVENT EXCESSIVE DRYING OR WETTING OF THE SOIL.

## **MASONRY NOTES**

- 1. ALL MASONRY WALLS ARE TO HAVE HORIZONTAL REINFORCEMENT WHICH DOES NOT EXCEED 16 INCHES ON CENTER VERTICALLY. SEE SPECIFICATIONS FOR INFORMATION RELATING TO CONCRETE BLOCK, BRICK, AND WALL REINFORCING.
- 2. ALL VERTICAL REINFORCING STEEL IN MASONRY WALLS ARE TO COMPLY WITH ASTM A615, GRADE 60. LAPS SHALL BE 48 BAR DIAMETERS (12" MINIMUM)
- 3. PROVIDE SPLICE BARS FOR ALL BOND BEAM REINFORCING AT ALL CORNERS. SPLICE BAR TO BE THE SAME SIZE AS BARS IN THE BOND BEAM. LAPS SHALL BE 50 BAR DIAMETER.
- 4. WHERE MASONRY IS APPLIED ADJACENT TO STEEL MEMBERS (BEAMS AND COLUMNS) PROVIDE ANCHORING DEVICES PER SPECIFICATIONS.
- 5. REFER TO ARCHITECTURAL PLANS FOR ROUGH OPENING LOCATIONS, SIZES, AND ELEVATIONS.
- 6. USE SIMPSON TITEN HD OR APPROVED EQUAL TYPE ANCHORS IN CMU WALL PARTITIONS.
- 7. ALL NON-STRUCTURAL CMU WALLS SHALL BE REINFORCED WITH A #3 VERTICAL BAR AT 48" OC WITH THAT CMU CORE GROUTED AND HORIZONTAL JOINT REINFORCEMENT AT 16" OC THE BOTTOM TWO COURSES SHALL BE GROUTED SOLID. PROVIDE CONTINUOUS BOND BEAM AT TOP OF WALL WITH 2 #4's CONTINUOUS GROUT BOND BEAM SOLID. PROVIDE #3 DOWEL AT 48" OC MATCH VERTICAL BAR, LAP 50 BAR DIAMETERS. PROVIDE LINTEL BLOCK AS BOND BEAM WITH (2) #5 x CONT, AND 8" BEARING EACH END. TYPICAL UNLESS NOTED OTHERWISE.
- 8. CONSTRUCTION BRACING FOR MASONRY WALLS SHALL BE DESIGNED BY A PROFESSIONAL ENGINEER LICENSED IN THE STATE IN WHICH THE PROJECT IS LOCATED. MASONRY SUBMITTALS SHALL CONTAIN A LETTER SEALED BY THE ENGINEER AND SHALL BE ISSUED TO THE OWNER AFTER SUBMITTAL REVIEW AND PRIOR TO STARTING MASONRY CONSTRUCTION.

# **COLD FORMED TRUSS NOTES**

- 1. TRUSS FABRICATOR SHALL DESIGN TRUSSES FOR LOADS SPECIFIED ON PLANS IN CONFORMANCE WITH "QUALITY CONTROL MANUAL" BY TPI. REFER TO THE ARCHITECTURAL DRAWINGS FOR ADDITIONAL DEAD LOADS RESULTING FROM DORMERS AND OTHER MISCELLANEOUS FRAMING. ALL TRUSSES SHALL BE DESIGNED FOR A MINIMUM OF 30 PSF LIVE LOAD PLUS 10 psf DEAD LOAD.
- 2. LIVE LOAD IS ON A HORIZONTAL PROJECTION OTHER LIVE LOADS SHOWN ON THE DRAWINGS ARE IN ADDITION
- 3. CHECK VERTICALLY PROJECTED ELEMENTS FOR DESIGN WIND LOAD.
- 4. DESIGN TRUSSES TO RESIST A NET UPLIFT OF 10 PSF.
- 5. SUBMIT SHOP DRAWINGS AND CALCULATIONS PRIOR TO FABRICATION
- CONFORM TO TPI SPECIFICATIONS.
- 7. FLOOR TRUSS LL DEFLECTION SHALL NOT EXCEED L/480.
- 8. ROOF TRUSS LL DEFLECTION SHALL NOT EXCEED L/360.
- 9. PERMANENT BRACING NOT SHOWN ON PLANS, WHICH IS REQUIRED FOR STRENGTH AND STABILITY OF TRUSS MEMBERS, SHALL BE DESIGNED AND PROVIDED BY TRUSS SUPPLIER.
- 10. ALL TRUSS TOP CHORDS SHALL BE CONTINUOUSLY BRACED BY THE (ROOF/FLOOR) DECKING. ALL ROOF TRUSS WEB MEMBERS SHALL BE BRACED AT 4'-0" OC UNLESS CALCULATIONS SHOW OTHERWISE.
- 11. TEMPORARY BRACING SHALL BE THE CONTRACTOR'S RESPONSIBILITY. PROVIDE IN ACCORDANCE WITH TPI GUIDELILNES.
- 12. PROVIDE 24" WIDE VIERENDEEL PANEL AT CENTER OF EACH PARALLEL CHORD TRUSS.

## STRUCTURAL STEEL NOTES

- 1. FABRICATION AND ERECTION OF STRUCTURAL STEEL SHALL CONFORM WITH THE AISC (AMERICAN INSTITUTE OF STEEL CONSTRUCTION), "MANUAL OF STEEL CONSTRUCTION", LATEST EDITION.
- 2. ALL STEEL DETAILS AND CONNECTIONS SHALL BE IN ACCORDANCE WITH THE REQUIREMENTS OF THE AISC "SPECIFICATIONS FOR STRUCTURAL STEEL BUILDINGS, ALLOWABLE STRESS DESIGN AND PLASTIC DESIGN",
- 3. ALL WELDING SHALL BE BY WELDERS HOLDING CURRENT VALID AWS CERTIFICATES IN THE TYPE OF WELD
- SHOP CONNECTIONS NOT SPECIFICALLY DETAILED ON THE DRAWINGS SHALL BE BOLTED OR WELDED. FIELD CONNECTIONS SHALL BE BOLTED UNLESS SPECIFICALLY DETAILED OTHERWISE.
- 5. DESIGN IN ACCORDANCE WITH GUIDE DETAILS AND REACTIONS

UNTIL PERMANENT FRAME IS COMPLETELY INSTALLED.

WELDED.

- 6. USE A325N BOLTS UNLESS NOTED OTHERWISE.
- 7. OVERSIZED OR SLOTTED HOLES SHALL NOT BE USED FOR ANY CONNECTIONS UNLESS SPECIFICALLY INDICATED ON THE DRAWINGS OR APPROVED IN WRITING BY THE ENGINEER.
- ALL BEAM COPES MUST BE MADE TO A RADIUS (1" MINIMUM). ALL BUTT AND FULL PENETRATION WELDS SHALL BE MADE USING RUN OFF TABS WHICH SHALL BE TRIMMED FLUSH AND GROUND SMOOTH AFTER WELD IS COMPLETED.
- 9. ALL WELDS INDICATED SHALL MEET THE MINIMUM WELD SIZE SPECIFIED BY THE CURRENT AISC MANUAL OF STEEL DESIGN. (SINGLE PASS AS REQUIRED).
- 10. CUTS, HOLES, COPING, ETC. REQUIRED FOR WORK OF OTHER TRADES SHALL BE SHOWN ON THE SHOP DRAWINGS AND MADE IN THE SHOP. CUTS OR BURNING OF HOLES IN STRUCTURAL STEEL MEMBERS IN THE FIELD WILL NOT BE PERMITTED.
- 11. PROVIDE ANY NECESSARY TEMPORARY BRACING OR GUYS TO PROVIDE LATERAL SUPPORT OF THE BUILDING
- 12. INSTALL EXPANSION BOLTS IN ACCORDANCE WITH THE ICBO REPORT RECOMMENDATIONS.
- 13. ALL ELEVATOR GUIDE BEAMS SHALL BE S8x18.4 UNLESS NOTED OTHERWISE. SLOPE TO MATCH BEAM SLOPE. 14. STRUCTURAL STEEL FRAMING SHALL BE TRUE AND PLUMB BEFORE CONNECTIONS ARE FINALLY BOLTED OR
- **EXPANSION** 1625 NORTHPORT DRIVE

RECREATION CENTER

WARNER PARK

**COMMUNITY** 

MILWAUKEE | MADISON | CHICAGO

www.otie.com Job Number 2023037

Office 608.243.6470 Fax 608.241.3914 5100 Eastpark Blvd, Suite 300,

Madison, Wisconsin 53718

Contractors are responsible for the means, methods,

including, but not limited to, temporary supports, shoring,

MADISON, WI 53704 CITY OF MADISON PARKS DIVISION 330 EAST LAKESIDE STREET

PROJECT NUMBER

NO. DESCRIPTION

1 ADDENDUM 2

MADISON, WI 53715

223471.00

DATE

6/13/2024

ISSUED FOR: 5/16/2024 **BID SET REVISION FOR:** 

DRAWN BY CHECKED BY

STRUCTURAL NOTES

## ABBREVIATION LIST

ANCHOR BOLT (ROD) AIR HANDLING UNIT ALT ALTERNATE ARCH **ARCHITECTURAL** BLDG BUILDING BRG BEARING BP(##) BASE PLATE CALL-OUT COLD-FORMED CIP CAST-IN-PLACE CJ **CONTROL JOINT** CENTER LINE CLR CLEAR (DISTANCE) CMU CONCRETE MASONRY UNIT COL COLUMN CONC CONCRETE CONTINUOUS DEFORMED BAR ANCHOR DBA DEMO DEMOLITION / DEMOLISH DIA DIAMETER DWG EOD EOS DRAWING EDGE OF DECK EDGE OF SLAB EACH FACE **EXPANSION JOINT** ELEV **ELEVATION** EQ EQUAL EW **EACH WAY EWEF** EACH WAY EACH FACE EXP EXPANSION EXT EXTERIOR EXTG **EXISTING** FD FLOOR DRAIN FLR FLOOR FV FIELD VERIFY F(##) FOOTING CALL-OUT GAUGE GALV GALVANIZED GC GENERAL CONTRACTOR GLULAM GLUE-LAMINATED BEAM(S) HOOK HORIZ HORIZONTAL **HIGH POINT** HEADED WELDED STUD(S) HWS


INSIDE FACE INTERIOR JBE JOIST BEARING ELEVATION LLH LONG LEG HORIZONTAL LONG LEG VERTICAL LLV LSL LAMINATED STRAND LUMBER LTWT LIGHTWEIGHT LVL LAMINATED VENEER LUMBER LONG WAY LW MAX MAXIMUM MECH MECHANICAL MFR MANUFACTURER MIN MINIMUM MISC **MISCELLANEOUS** NA **NOT APPLICABLE** NTS NOT TO SCALE OC ON CENTER OUTSIDE FACE OPNG OPENING **OPPOSITE** PRECAST / PRESTRESSED

OPP PC PCI POUNDS PER CUBIC INCH PDF POUNDS PER CUBIC FOOT PLATE POUNDS PER LINEAR FOOT PLF **PROJ** PROJECTION PSF POUNDS PER CUBIC FOOT POUNDS PER SQUARE INCH PRE (POST) -TENSIONED PIER CALL-OUT P(#) RD ROOF DRAIN REINF REINFORC(ED)(ING) RTU SIM ROOF TOP UNIT SIMILAR SOG SLAB-ON-GRADE SPA SPAC(ES)(ED)(ING)

OF

SPEC SPECIFICATION(S) SQ SQUARE STAINLESS STEEL SHORT WAY TOP OF LEDGE TOP OF PIER TOP OF WALL TW TYP **TYPICAL** UNO UNLESS NOTED OTHERWISE **VERT** VERTICAL WP **WORKING POINT** WWF WELDED WIRE FABRIC

# FOUNDATION LEGEND

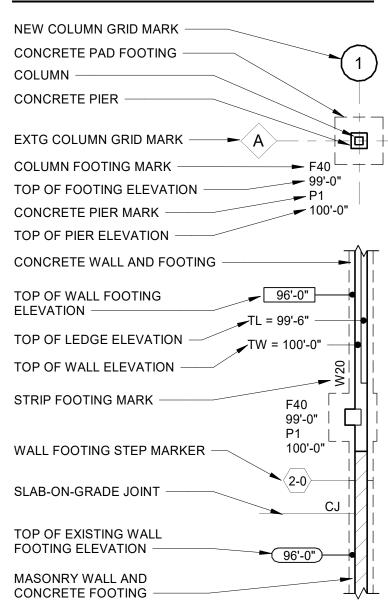


LINTEL SCHEDULE					
LENGTH	SIZE AND REINFORCING	NOTE/ REMARKS			
0'-4"	8" W x 8" H BOND BM W/ (2) #5 BOT	SEE ARCH FOR LOCATIONS			
4'-8"	8" W x 16" H BOND BM W/ (2) #5 BOT	SEE ARCH FOR LOCATIONS			

- 1. AT NEW WALLS, REINFORCE AT BEARING WITH (1) #5 VERT FULL HEIGHT OF WALL FROM FLOOR TO FLOOR OR FLOOR TO ROOF.
- 2. AT EXISTING WALLS, BEAR LINTEL ON MIN (2) COURSES GROUTED
- 3. AT EXTERIOR OPENINGS, PROVIDE GALV BENT PL5/16"x7 1/2"x7 1/2" x CONT TO OPENING CORNERS.
- 4. 8" MIN BEARING AT ENDS.

MASONRY PIER SCHEDULE								
MARK	SIZE (LENGTH)	TYPE	VERTICAL REINFORCING	CLOSED LOOP TIE	COMMENTS			
MP1	16"	III	(6) #6	(2) SETS OF 1/4" AT 8"				
MP2	24"	IV	(8) #6	(2) SETS OF 1/4" AT 8"				

- 1. ALL REINFORCED CMU CORES ARE GROUTED SOLID.
- 2. RUN HORIZONTAL JOINT REINFORCING CONT. THROUGH MASONRY PIERS.
- 3. USE 1/4" (2) RODS AS CLOSED LOOP TIES.
- 4. USE BOND BEAM CMU BLOCKS OR DROP TOP CMU BLOCK AT MASONRY PIERS WITH TIES.
- 5. SIZE IS WALL WIDTH x LENGTH.

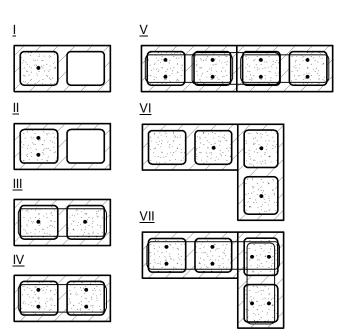

WALL FOOTING SCHEDULE									
	CONTINUOUS FOOTING DIMENSIONS								
MARK	WIDTH	THICKNESS	FOOTING REINFORCEMENT	REMARKS					
W24	2' - 4"	1' - 0"	(3) #5; B, CONT						
W28	2' - 8"	1' - 0"	(3) #6; B, CONT						
W30	3' - 0"	1' - 0"	(3) #6; B, CONT						
W36	3' - 6"	1' - 0"	(x) #X; B, CONT						
W90	9' - 0"	1' - 8"	(7) @ 12" T&B, EW						

MASONRY WALL REINFORCEMENT SCHEDULE									
MARK	WALL REINFORCEMENT		NOTES						
WARK	TYPE	VERTICAL	HORIZONTAL	NOTES					
$\langle A \rangle$	12" CMU	#6 AT 16" OC	HJR AT 16" OC	BOND BEAM WITH (1) #5 AT 40" OC AND AT BOTTOM OF WALL					
В	12" CMU	#8 AT 8" OC	HJR AT 16" OC	VERTICAL REINFORCING TO BE AT EXTERIOR FACE OF CMU					
C	8" CMU	#6 AT 16" OC	HJR AT 16" OC	BOND BEAM WITH (1) #5 AT 40" OC AND AT BOTTOM OF WALL					

#### NOTES:


- 1. SEE ARCHITECTURAL WALL TYPES FOR ADDITIONAL REQUIREMENTS.
- 2. REINFORCEMENT IS TO BE LOCATED IN CENTER OF WALL UNO.
- 3. PROVIDE CONTINUOUS BOND BEAM WITH (2) #5 AT ALL BEARING ELEVATIONS AND OVER WINDOWS DOORS AND OTHER OPENINGS UNO.
- 4. PROVIDE HORIZONTAL REINFORCEMENT INTO INTERSECTING WALLS AT 16" OC VERTICAL. EXTENT 30" EACH DIRECTION WITH PREFABRICATED "T" AND "L" SECTION TYP.
- 5. SEE GENERAL MASONRY NOTES ON SHEET S001 FOR NON LOAD BEARING WALL REINFORCEMENT REQUIREMENTS.
- 6. PROVIDE DOWELS TO MATCH VERTICAL REINFORCEMENT. EMBED DOWELS 30" INTO

	BASE PLATE SCHEDULE								
MARK	SIZE 't' x 'w' x 'L'	ANCHOR RODS	BASE PLATE TYPE	NOTES					
BP1	3/4" x 9" x 0'-9"	(4) 3/4" DIA x 4"	1	TYPICAL HSS4x4x1/2					
BP2	3/4" x 11" x 0'-9"	(4) 3/4" DIA x 4"	2	TYPICAL HSS5x3x5/16					

#### BASE PLATE NOTES:

1. FASTEN STEEL COLUMN TO TOP OF CONCRETE USING (4) F1554 [36] [55] [105] ANCHOR RODS OF SIZE INDICATED WITH DOUBLE NUTS AT COLUMN BASE PLATE. AND 1 1/2" GROUT AT 3/4" DIAMETER ANCHOR RODS AND 2" GROUT AT 1" DIAMETER ANCHOR RODS, SET ANCHOR RODS WITH 6" PROJECTION

## BASE PLATE TYPES:

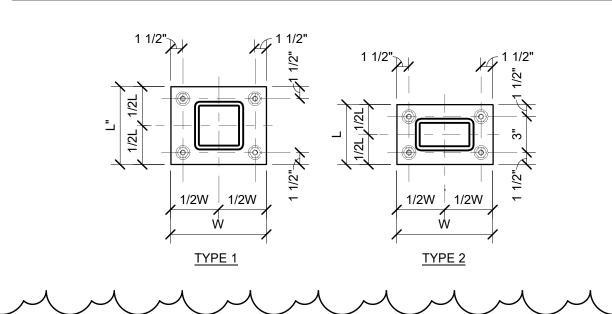

# LOOSE STEEL LINTEL SCHEDULE

PROVIDE WHERE OTHER LINTELS ARE NOT SPECIFICALLY DETAILED WALL | CLEAR MASONRY THICK OPENING WIDTH ALL AT FIRE 1/4" PLATE **EXTINGUISHER** CABINETS AND DRINKING **FOUNTAINS** TO 5'-0" ST3x6.25 3/16 1 1/2-8 4" TO 7'-0" PL 3/8 x 4 1/2 ON PL 3/8 x 3 1/2 TO 9'-0" PL3/8"x7 1/2" ON PL3/8"x3 1/2" (2) L3 1/2x2 1/2x1/4 (LLV) TO 5'-0" TO 7'-0" WT4x10.5 TO 9'-0" WT7x11 6" TO 12'-0" WT7x13 WITH PL1/2"x2" 3/16 1 1/2-8 8" TO 5'-0" (2) L3 1/2x3 1/2x1/4 **ا**ل TO 7'-0" (2) L4x3 1/2x5/16 (LLV) JL TO 9'-0" WT7x15 10" TO 7'-0" W8x10 WITH PL5/16"x9" 3/16 1 1/2-8 TO 10'-0" W8x15 WITH PL5/16"x9" 12" TO 5'-0" (3) L3 1/2x3 1/2x1/4 JLL 12" TO 7'-0" W8x10 WITH PL5/16"x11" 3/16 1 1/2-8 12" TO 10'-0" W8x15 WITH PL5/16"x11"


## NOTES:

- 1. PROVIDE MINIMUM 8" BEARING AT EACH END OF LINTEL.
- 2. GROUT BLOCK CORES AND REINFORCE WITH (1) #5 VERT BELOW LINTEL BEARING.
- 3. CENTER LINTELS IN WALL UNLESS OTHERWISE NOTED.
- 4. BOTTOM PLATES UNDER WIDE FLANGE SHAPES SHALL BE EXTENDED FULL LENGTH OF LINTEL.
- 5. WELD LINTEL COMPONENTS INTO SINGLE UNIT.
- 6. NOT LINTELS ARE REQUIRED FOR 4" AND 6" NON-BEARING MASONRY WALLS WHERE GROUTED HOLLOW METAL FRAMES HAVE A HEADSPAN OF 4'-0" OR LESS.

BRICK LOOSE LINTEL SCHEDULE								
MARK	SECTION	NOTE/ REMARKS						
W ≤ 4'-0"	L4x4x5/16							
6'-6" < L < 9'-0"	L6x4x3/8							
9'-0" < L < 12'-0"	L7x4x1/2							
12'-0" < L < 15'-0"	L8x4x3/4							

## NOTES:

- 1. LINTELS TO BE SHOP PAINTED WITH ZINC RICK URETHANE. SEE SPECIFICATIONS.
- 2. PROVIDE 4" MIN BEARING EACH END OF LINTEL UNDER 9'-0". 8" BEARING FOR LONGER LINTELS.
- 3. SEE ARCH FOR CONTROL JOINT LOCATIONS AND FLASHING REQUIREMENTS.

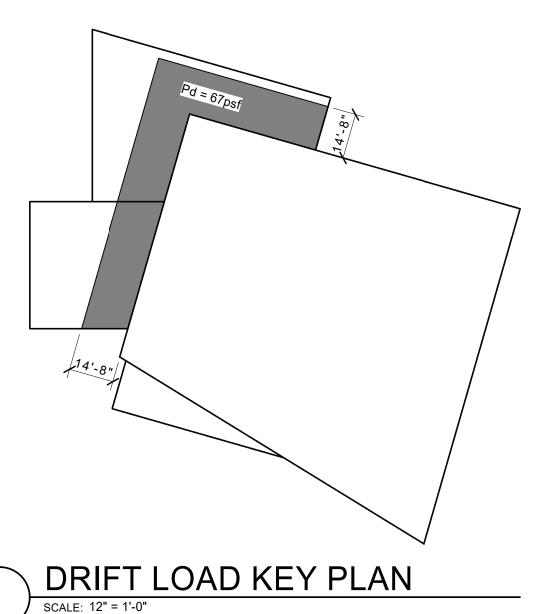

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Enterprises

www.otie.com Job Number 2023037 Office 608.243.6470 Fax 608.241.3914 5100 Eastpark Blvd, Suite 300, Madison, Wisconsin 53718

Contractors are responsible for the means, methods, including, but not limited to, temporary supports, shoring,

## WARNER PARK COMMUNITY **RECREATION CENTER EXPANSION**

1625 NORTHPORT DRIVE MADISON, WI 53704

CITY OF MADISON PARKS DIVISION 330 EAST LAKESIDE STREET MADISON, WI 53715

PROJECT NUMBER

223471.00

DATE

ISSUED FOR: 5/16/2024 **BID SET** 


**REVISION FOR:** NO. DESCRIPTION

1 ADDENDUM 2 6/13/2024

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STRUCTURAL SCHEDULES

**S002** 

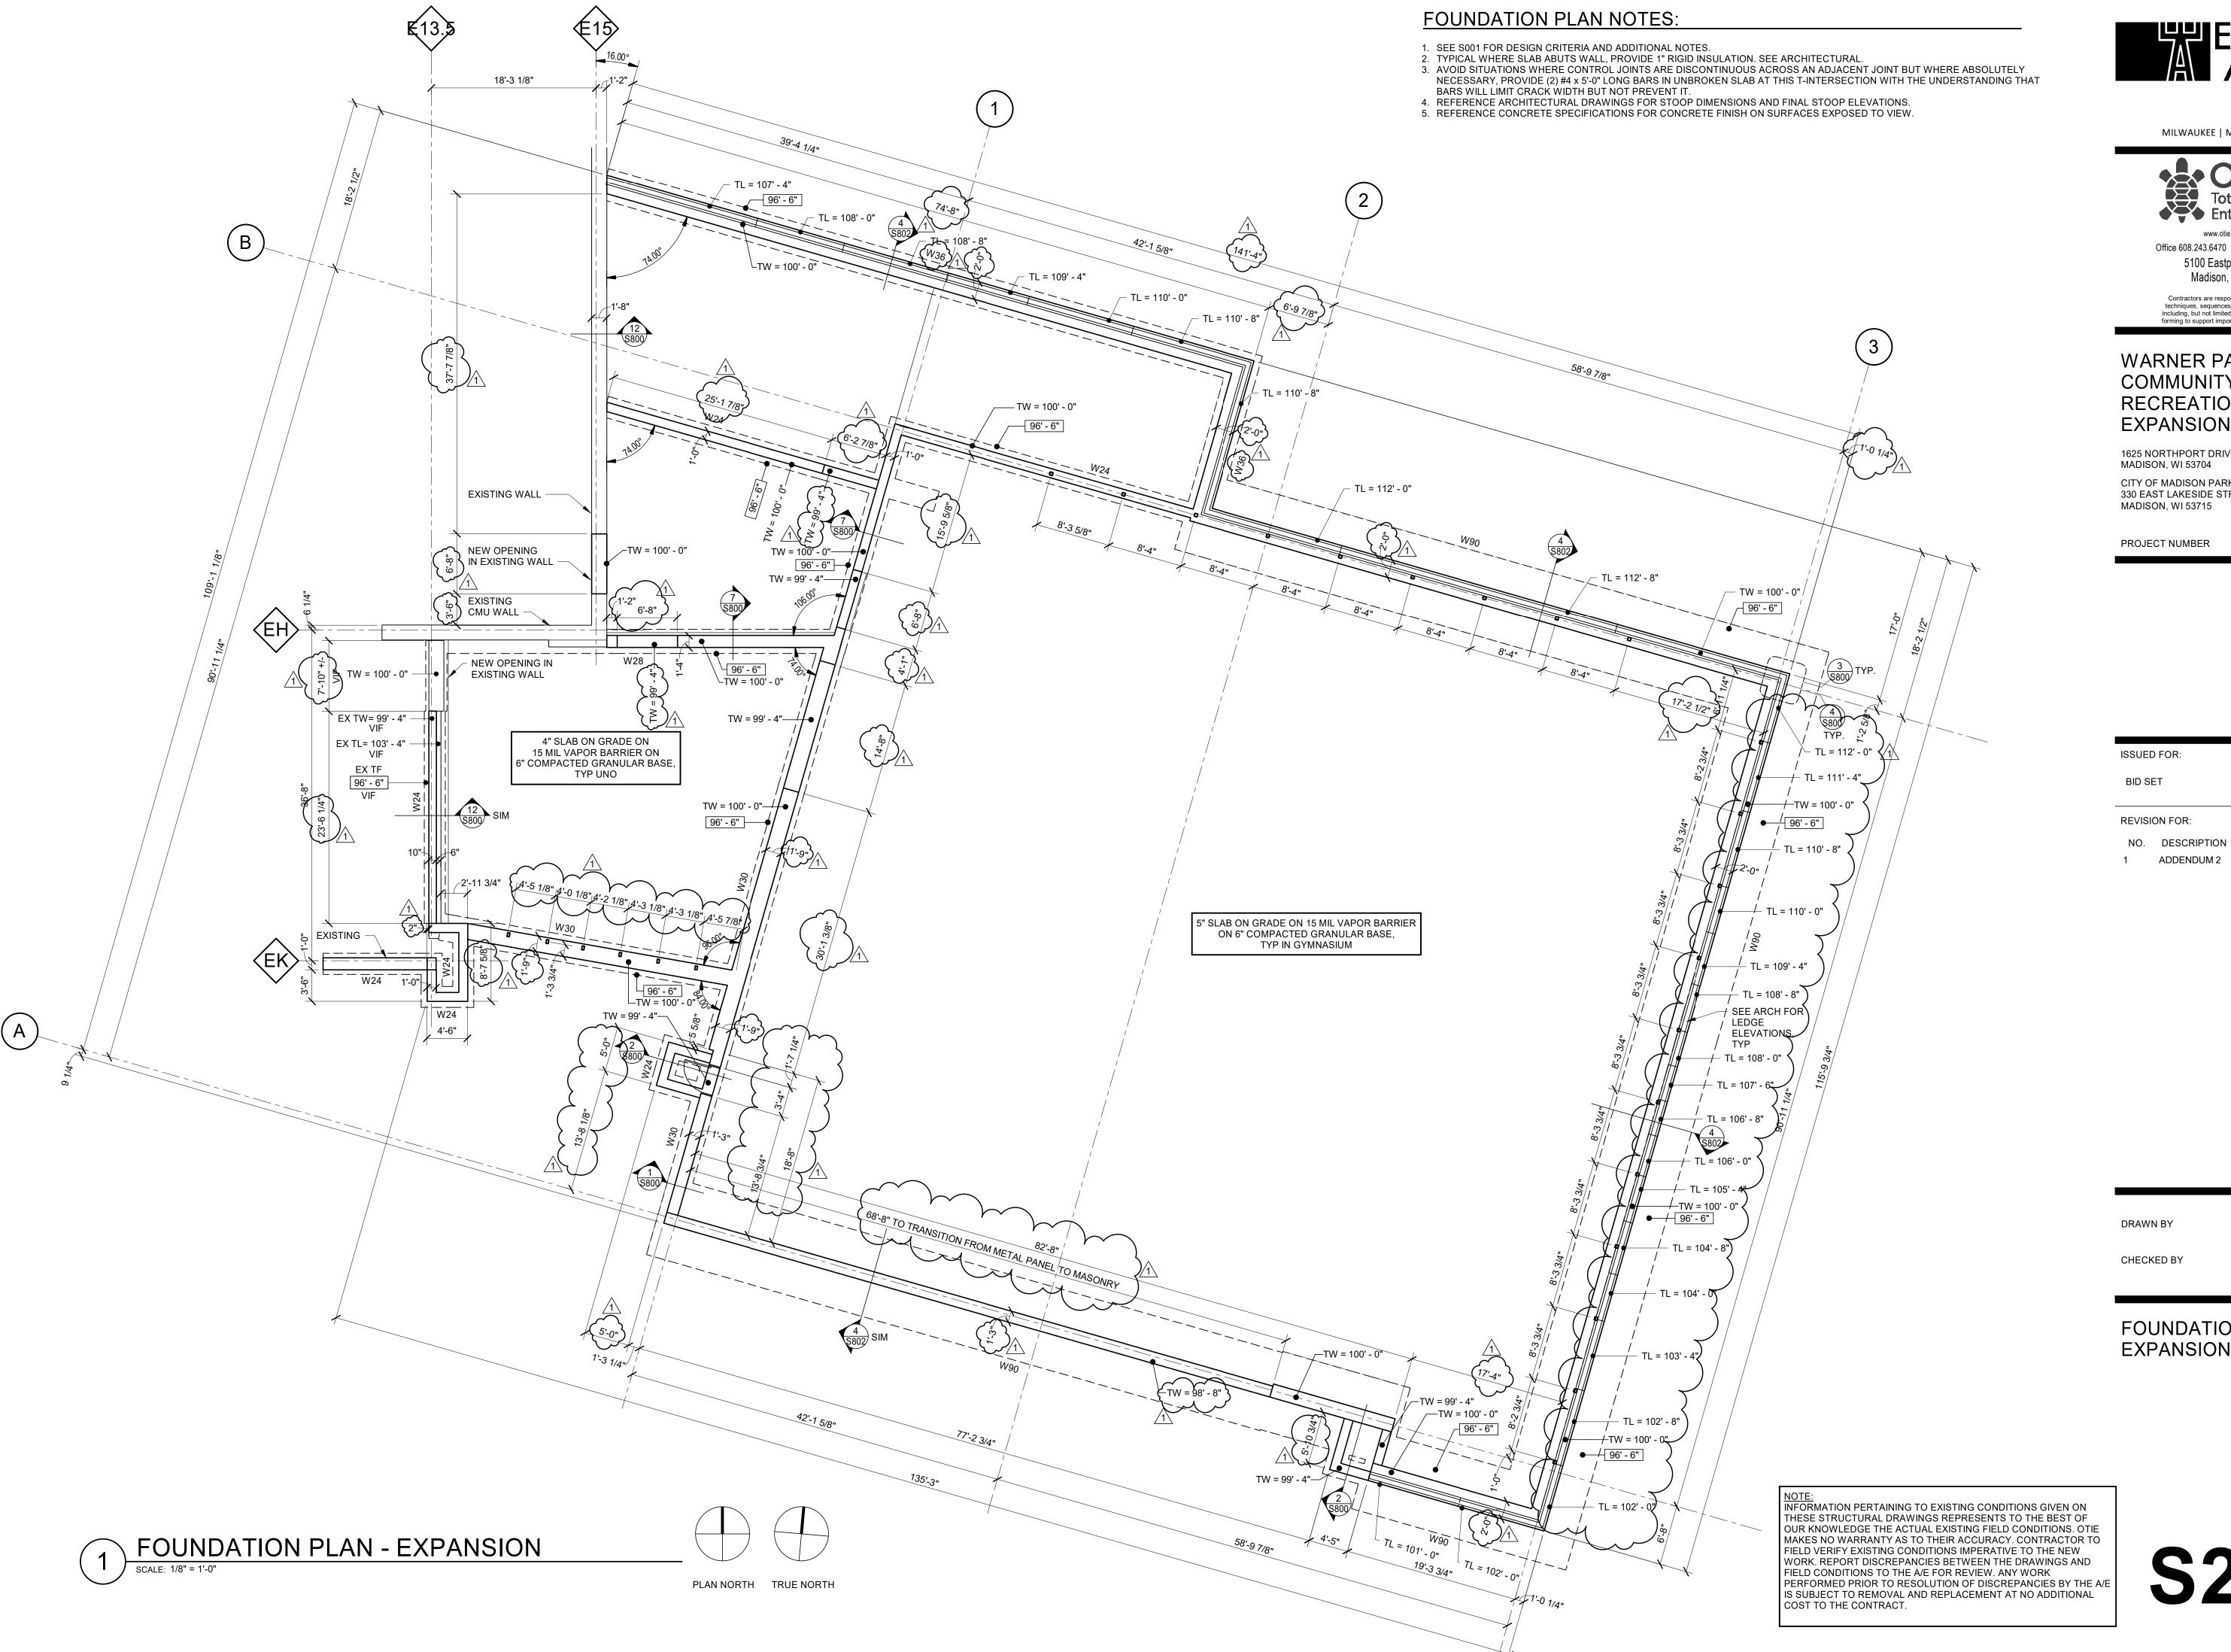

**Enterprises** 

Office 608.243.6470 Fax 608.241.3914 5100 Eastpark Blvd, Suite 300, Madison, Wisconsin 53718

www.otie.com Job Number 2023037

Contractors are responsible for the means, methods, techniques, sequences and procedures of construction including, but not limited to, temporary supports, shoring, forming to support imposed loads and other similar items.

# WARNER PARK COMMUNITY RECREATION CENTER **EXPANSION**

1625 NORTHPORT DRIVE MADISON, WI 53704

CITY OF MADISON PARKS DIVISION 330 EAST LAKESIDE STREET MADISON, WI 53715

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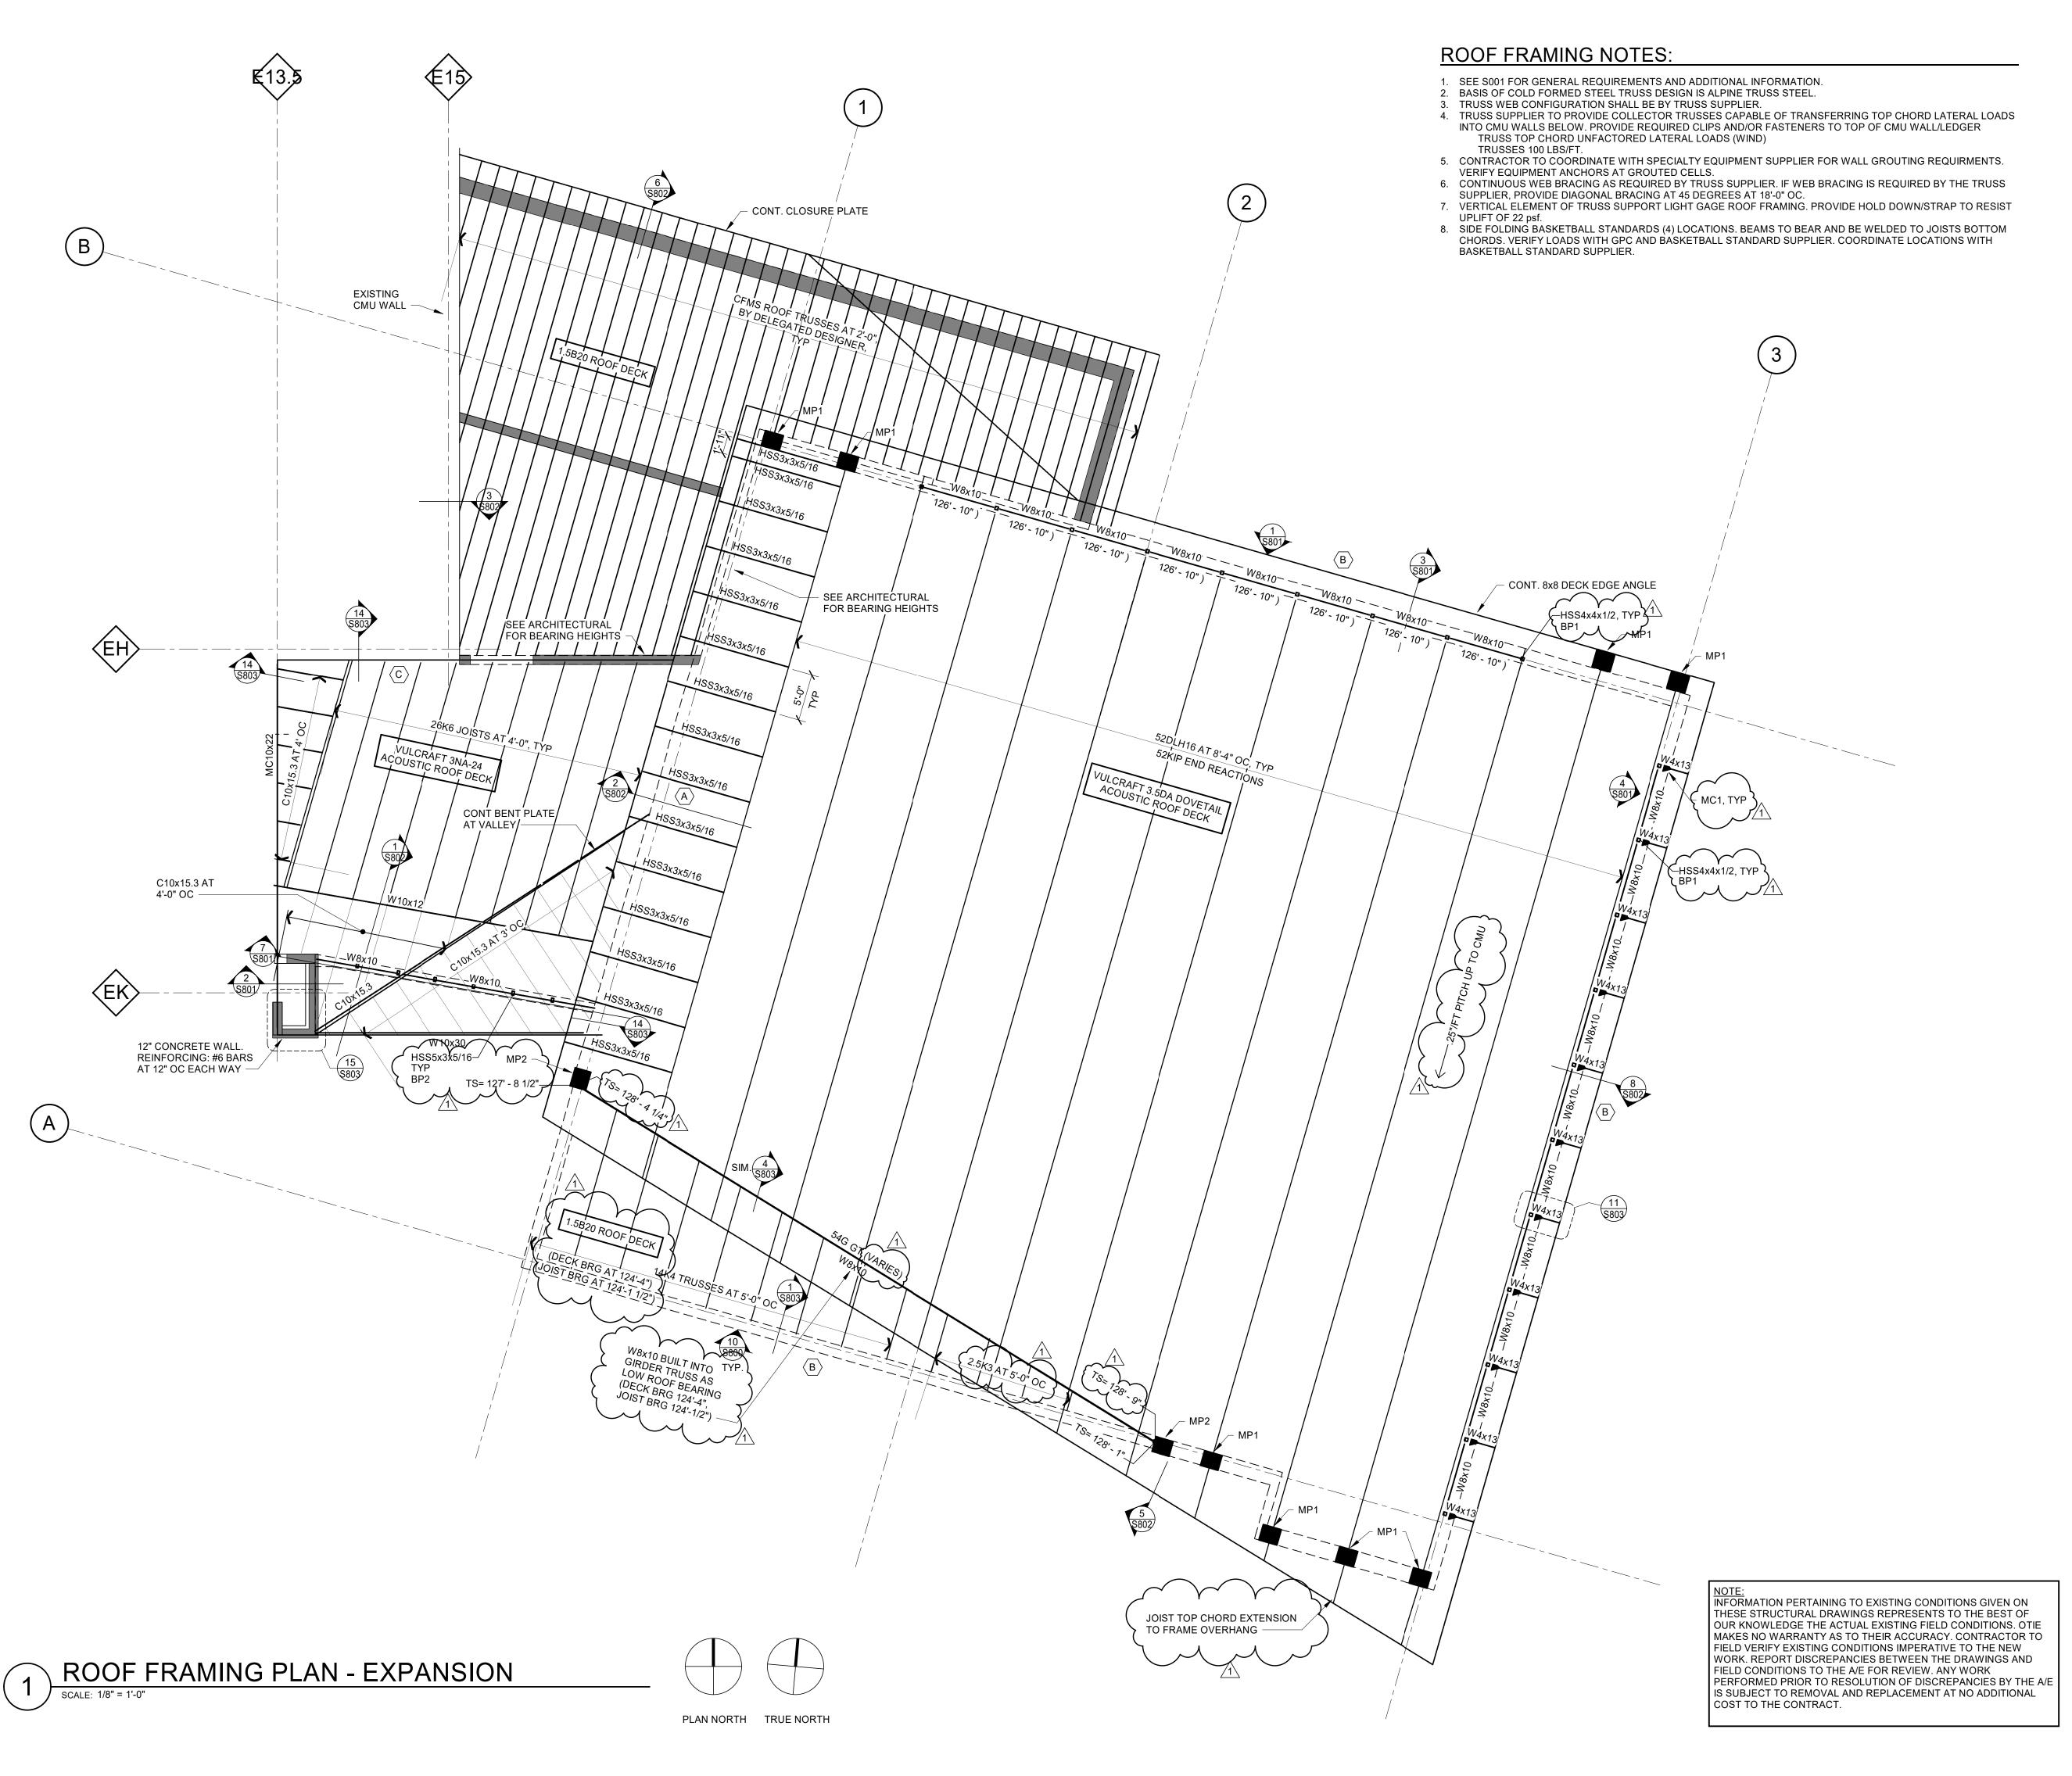
1 ADDENDUM 2

DATE 6/13/2024

223471.00

FOUNDATION PLAN -**EXPANSION** 

**S200** 







Office 608.243.6470 Fax 608.241.3914 5100 Eastpark Blvd, Suite 300, Madison, Wisconsin 53718

www.otie.com Job Number 2023037

Contractors are responsible for the means, methods, techniques, sequences and procedures of construction including, but not limited to, temporary supports, shoring, forming to support imposed loads and other similar items.

# WARNER PARK COMMUNITY RECREATION CENTER EXPANSION

1625 NORTHPORT DRIVE MADISON, WI 53704

CITY OF MADISON PARKS DIVISION 330 EAST LAKESIDE STREET MADISON, WI 53715

PROJECT NUMBER

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REVISION FOR:

ISSUED FOR:

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1 ADDENDUM 2

DATE 6/13/2024

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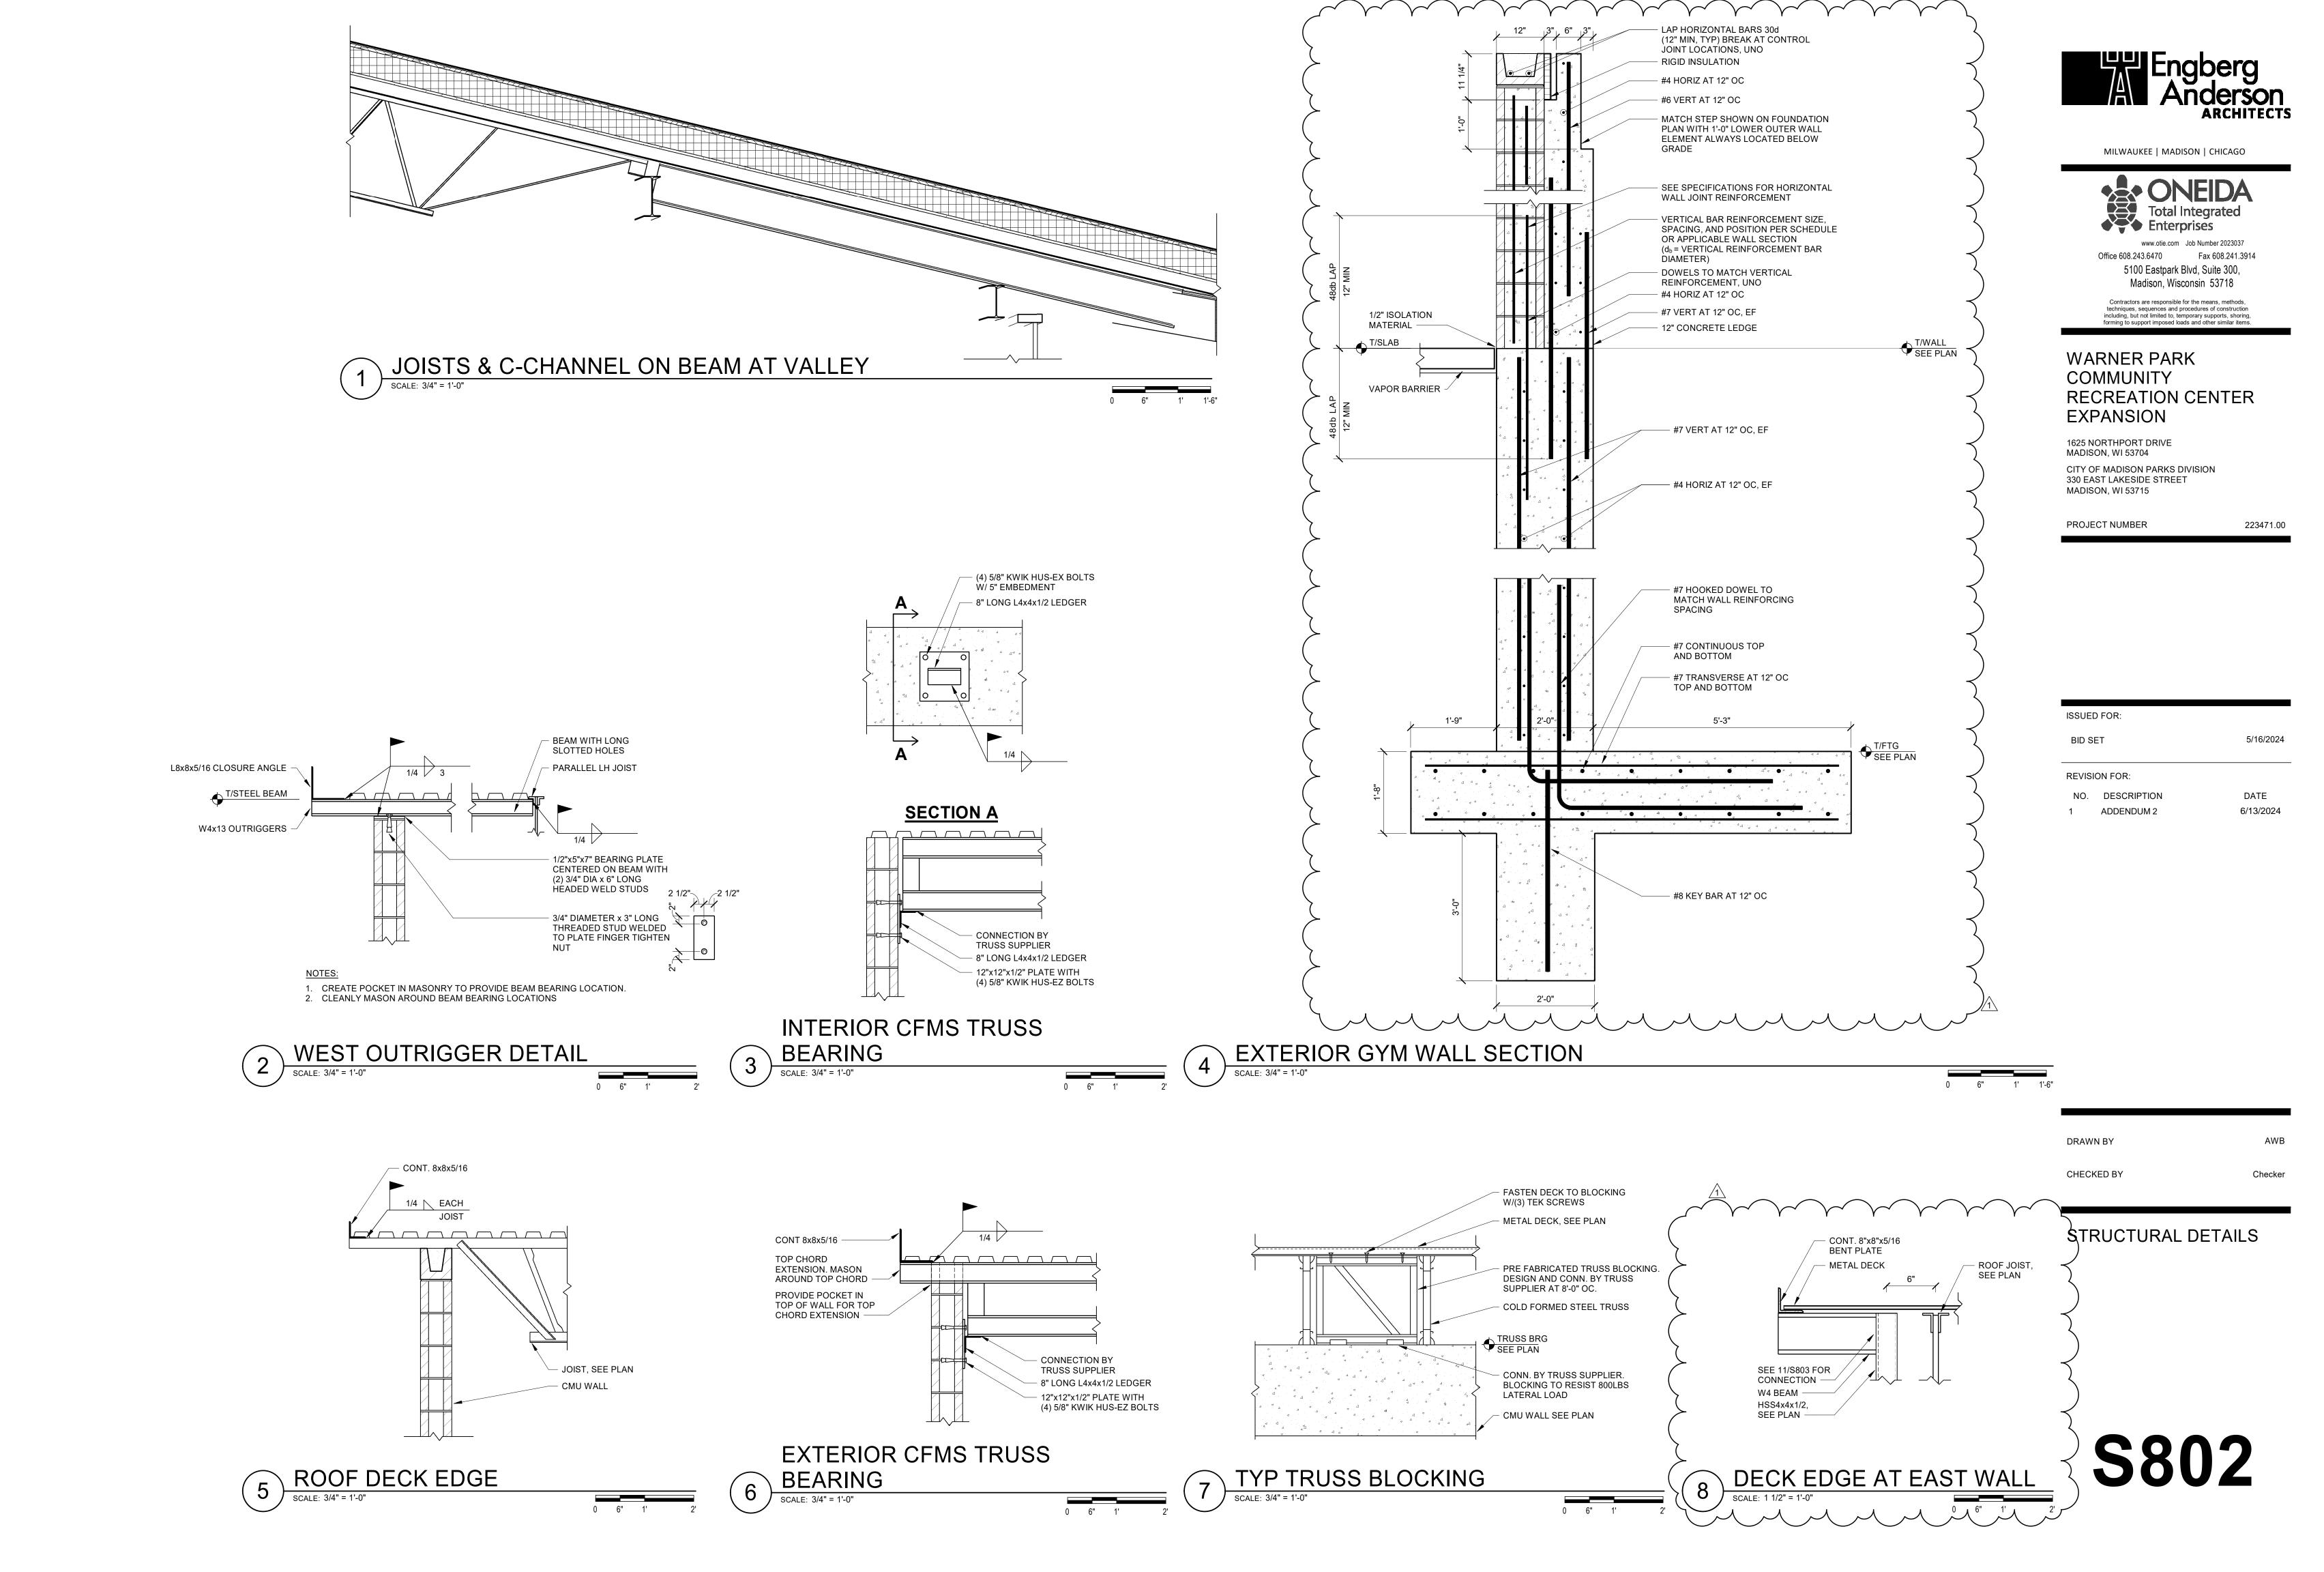
223471.00

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ROOF FRAMING PLAN - EXPANSION

**S201** 



			WASTE			WA	TED			
ID	FIXTURE		WASTE	\	CC	DLD	TER HO	)T	DETAIL /	DESCRIPTION / REMARKS
טו	TIXTORE	DFU	TRAP	VENT (MIN)	CWFU		HWFU		SHEET	DESCRIPTION / REMARKS
										FIXTURE: ELKAY LVRCGRN8WSK WALL HUNG, VANDAL RESISTANT ELECTRIC WATER COOLER WITH BOTTLE FILLING STATION AND FILTER, LIGHT GRAY GRANITE FINISH, SELF CLOSING PUSH BUTTON VALVE CONTROLS, SELF-CONTAINED CHILLER UNDER FIXTURE, ADA COMPLIANT. FIXTURE TO BE MOUNTED AT STANDARD HEIGHT.
NC-1	ELECTRIC WATER COOLER WITH BOTTLE FILLER	1	1 1/2"	1 1/2"	0.25	1/2"				TRAP & DRAIN: CHROME PLATED 17 GAUGE CAST BRASS TRAP.
	(ADA COMPLIANT)									STOPS & SUPPLIES: McGUIRE LFBV2165CC, LOOSE KEY QUARTER TURN ANGLE STOPS WITH CHROME PLATED ESCUTCHEONS & CHROME PLATED COPPER RISER SUPPLIES.
										SUPPORT: MANUFACTURER'S RECOMMENDED WALL BRACKET AND COMPONENTS.
										FIXTURE: ELKAY LVRCGRNTL8WSK WALL HUNG VANDAL RESISTANT HI-LO ELECTRIC WATER COOLER WITH BOTTLE FILLING STATION AND FILTER, LIGHT GRAY GRANITE FIN SELF-CLOSING PUSH BUTTON VALVE CONTROLS, SELF-CONTAINED CHILLER UNDER FIXTURE, ADA COMPLIANT. FIXTURE TO BE MOUNTED AT ADA HEIGHT.
VC-2	ELECTRIC WATER COOLER WITH BOTTLE FILLER	1	1 1/2"	1 1/2"	0.25	1/2"				TRAP & DRAIN: CHROME PLATED 17 GAUGE CAST BRASS TRAP.
<u> </u>	(HI-LO)		1 1/2	1 1/2	0.23	1/2				STOPS & SUPPLIES: McGUIRE LFBV2165CC, LOOSE KEY QUARTER TURN ANGLE STOPS WITH CHROME PLATED ESCUTCHEONS & CHROME PLATED COPPER RISER SUPPLIES.
										SUPPORT: MANUFACTURER'S RECOMMENDED WALL BRACKET AND COMPONENTS.
<u> HB-1</u>	HOSE BIBB				3	1/2"				FIXTURE: WOODFORD MODEL 24 ANTI-SIPHON HOSE BIBB, EXPOSED COLD WATER, INTEGRAL VACUUM BREAKER, 3/4" HOSE CONNECTION.
										FIXTURE: SLOAN AD-82000 CLARK STREET WALL MOUNTED TWIN STATION LAVATORY SINK, COORDINATE COLOR WITH ARCHITECT, ADA COMPLIANT. PROVIDE SUPPORT AS REQUIRED BY MANUFACTURER.
1.4	LAVATORY	4	4 4/4"	4.4/0"	0.5	4 /0"	0.5	4/0"		FAUCET: (2) SLOAN OPTIMA ETF-410 HARDWIRED ELECTRONIC FAUCET, 0.35 GPM AERATOR, SINGLE HOLE MOUNTING, CHROME FINISH, SENSOR OPERATED, BOX TRANSFORMER POWER SUPPLY. INCLUDE STATE APPROVED BELOW DECK MIXING VALVE. REFER TO ARCHITECTURAL ELEVATIONS FOR LAYOUT OF FAUCETS.
<u>L-1</u>	(DOUBLE STATION)	1	1 1/4"	1 1/2"	0.5	1/2"	0.5	1/2"		ACCESSORIES: (2) SLOAN ESD-410-CP HARDWIRED FOAM SOAP DISPENSER, CHROME FINISH. INCLUDE ESD-324 PLUG-IN POWER ACCESSORY. (1) XLERATOR XL-SYNC-C-120 HAND DRYER, CHROME FINISH. REFER TO ARCHITECTURAL ELEVATIONS FOR LAYOUT OF ACCESSORIES.
										TRAP & DRAIN: PROVIDE McGUIRE PROWRAP PRE-WRAPPED OFFSET DRAIN AND P-TRAP, CHROME PLATED 17 GAUGE CAST BRASS TRAP, WITH GRID STRAINER DRAIN.
										STOPS & SUPPLIES: QUARTER TURN ANGLE STOPS WITH CHROME PLATED ESCUTCHEONS & CHROME PLATED COPPER RISER SUPPLIES.
										FIXTURE: SLOAN AD-81000 CLARK STREET WALL MOUNTED SINGLE STATION LAVATORY SINK, COORDINATE COLOR WITH ARCHITECT, ADA COMPLIANT. PROVIDE SUPPORT A REQUIRED BY MANUFACTURER.
<u>L-2</u>	LAVATORY	1	1 1/4"	1 1/2"	0.5	1/2"	0.5	1/2"		FAUCET: (1) SLOAN OPTIMA ETF-410 HARDWIRED ELECTRONIC FAUCET, 0.35 GPM AERATOR, SINGLE HOLE MOUNTING, CHROME FINISH, SENSOR OPERATED, BOX TRANSFORMER POWER SUPPLY. INCLUDE STATE APPROVED BELOW DECK MIXING VALVE. REFER TO ARCHITECTURAL ELEVATIONS FOR LAYOUT OF FAUCET.
<u>L-Z</u>	(SINGLE STATION)	ı	1 1/4	1 1/2	0.0	1/2	0.0	1/2		ACCESSORIES: (1) SLOAN ESD-410-CP HARDWIRED FOAM SOAP DISPENSER, CHROME FINISH. INCLUDE ESD-324 PLUG-IN POWER ACCESSORY. (1) XLERATOR XL-SYNC-C-120 HAND DRYER, CHROME FINISH. REFER TO ARCHITECTURAL ELEVATIONS FOR LAYOUT OF ACCESSORIES.
										TRAP & DRAIN: PROVIDE McGUIRE PROWRAP PRE-WRAPPED OFFSET DRAIN AND P-TRAP, CHROME PLATED 17 GAUGE CAST BRASS TRAP, WITH GRID STRAINER DRAIN.
<u>~~~</u>		$\sim$	$\sim$	$\sim$	$\sim$	$\sim$	$\sim$	$\sim$	$\overline{\gamma}$	YETOPS & SUPPLIES: AGUARTER TURN ANGLE STOPS WITH CHROME PLATED ESCUTCHEONS & CARROME PLATED COPPER ATSER SUPPLIES: //////
										ENCLOSURE: FIELD BUILT BY OTHERS.
<u>SH-1</u>	SHOWER (ADA COMPLIANT)	2	2"	1 1/2"	2	1/2"	2	1/2"		FIXTURE INCLUDING CONTROLS: ACORN 538-CSH-WSB-DIV-FX-QD-RD SHOWER SYSTEM, 1.5 GPM, ONE FIXED CONICAL SHOWER HEAD MOUNTED ON WALL, REFER TO ARCHITECTURAL PLANS FOR FIXED SHOWER HEAD MOUNTING HEIGHT, ANTI-LIGATURE TEMPERATURE / VOLUME CONTROL WITH INTEGRAL STOPS, TEMP-PRESSURE BALANCING VALVE. INCLUDE DIVERTER VALVE WITH HANDHELD SHOWER & 60" STAINLESS STEEL HOSE WITH QUICK DISCONNECT. PC TO PROVIDE 14 GAUGE STAINLESS STEEL PANEL FOR SHOWER CONTROL AND DIVERTER VALVE. COORDINATE SIZE AND LOCATION OF 14 GAUGE STAINLESS STEEL PANEL WITH GC. TEMPERATURE CONTRO AND DIVERTER VALVE MOUNTED ON 14 GAUGE STAINLESS STEEL PANEL, VALVE CONCEALED BEHIND PANEL, ADA COMPLIANT. HAND SHOWER, 14 GAUGE STAINLESS STEE PANEL, AND CONTROLS TO BE INSTALLED ON NORTH (LONG SIDE) WALL. SHOWER HEAD TO BE INSTALLED ON EAST (SHORT SIDE) WALL.
										DRAIN: FLOOR DRAIN FD-1 IN SHOWER FLOOR.
$\mathcal{A}$	munum			$\overline{\mathcal{M}}$	~~	Juni	June 1	m		LEXTURE: ZURNOMNILELQ ZER55-U, WALL-HUNG URINAL D.FIGER, ELUSHQMETERTYPE, WASHOUT, 3/47, TOR SPUD, WHITE VITBEQUEYCHINA, MOUNTED ATYSTANDARD HEIGHT
<u>UR-1</u>	URINAL (STANDARD HEIGHT)	2	2"	1 1/2"	2	3/4"				FLUSH VALVE: ZURN AQUASENSE ZER6003AV-HET-TM-HW, CONCEALED SENSOR OPERATED HARDWIRED URINAL FLUSH VALVE, INFRARED SENSOR, 3/4" TOP SPUD, 0.5 GPF DIAPHRAGM TYPE, ELECTRICAL OVERRIDE, POLISHED CHROME FINISH, ADA COMPLIANT. PROVIDE ZURN P6000-HW6 HARDWIRED POWER CONVERTER.
										SUPPORT: COMMERCIAL GRADE, WALL HUNG URINAL SUPPORT, STEEL STANCHIONS, IRON WELDED FEET, STEEL SLEEVES, FASTEN TO FLOOR.
<u> </u>	URINAL	2	2"	1 1/2"	2	3/4"				FIXTURE: ZURN OMNI-FLO Z5755-U, WALL HUNG URINAL, 0.5 GPF, FLUSHOMETER TYPE, WASHOUT, 3/4" TOP SPUD, WHITE VITREOUS CHINA, MOUNTED AT ADA HEIGHT.  FLUSH VALVE: ZURN AQUASENSE ZER6003AV-HET-TM-HW, CONCEALED SENSOR OPERATED HARDWIRED URINAL FLUSH VALVE, INFRARED SENSOR, 3/4" TOP SPUD, 0.5 GPF
	(ADA HEIGHT)									DIAPHRAGM TYPE, ELECTRICAL OVERRIDE, POLISHED CHROME FINISH, ADA COMPLIANT. PROVIDE ZURN P6000-HW6 HARDWIRED POWER CONVERTER.
										SUPPORT: COMMERCIAL GRADE, WALL HUNG URINAL SUPPORT, STEEL STANCHIONS, IRON WELDED FEET, STEEL SLEEVES, FASTEN TO FLOOR.
										FIXTURE: ZURN ECO VANTAGE HET WALL HUNG TOILET Z5615-BWL-AM, FLUSH VALVE TOILET, WHITE VITREOUS CHINA, ELONGATED BOWL, ZURNSHEILD CERAMIC GLAZE, 1 GPF MAX, 2.125" TRAPWAY, 1-1/2" TOP SPUD, MOUNTED AT ADA HEIGHT.
<u>WC-1</u>	WATER CLOSET (STANDARD HEIGHT)	6	4"	2"	6.5	1 1/2"				FLUSH VALVE: ZURN AQUASENSE ZER6000AV-HET-TM-HW, CONCEALED SENSOR OPERATED HARDWIRED FLUSH VALVE, INFRARED SENSOR, 1-1/2" TOP SPUD, 1.28 GPF, DIAPHRAGM TYPE, ELECTRICAL OVERRIDE, POLISHED CHROME FINISH, ADA COMPLIANT. PROVIDE ZURN P6000-HW6 HARDWIRED POWER CONVERTER.
										SEAT: ZURN Z5955SS-EL-AM, OPEN FRONT TOILET SEAT, WHITE INJECTION MOLDED, SELF SUSTAINING CHECK HINGES, ANTI-MICROBIAL AGENT.  SUPPORT: COMMERCIAL GRADE WATER CLOSET CARRIER.
										FIXTURE: ZURN ECO VANTAGE HET WALL HUNG TOILET Z5615-BWL-AM, FLUSH VALVE TOILET, WHITE VITREOUS CHINA, ELONGATED BOWL, ZURNSHEILD CERAMIC GLAZE, 1. GPF MAX, 2.125" TRAPWAY, 1-1/2" TOP SPUD, MOUNTED AT ADA HEIGHT.
<u>WC-2</u>	WATER CLOSET (ADA HEIGHT)	6	4"	2"	6.5	1 1/2"				FLUSH VALVE: ZURN AQUASENSE ZER6000AV-HET-TM-HW, CONCEALED SENSOR OPERATED HARDWIRED FLUSH VALVE, INFRARED SENSOR, 1-1/2" TOP SPUD, 1.28 GPF, DIAPHRAGM TYPE, ELECTRICAL OVERRIDE, POLISHED CHROME FINISH, ADA COMPLIANT. PROVIDE ZURN P6000-HW6 HARDWIRED POWER CONVERTER.
	,									SEAT: ZURN Z5955SS-EL-AM, OPEN FRONT TOILET SEAT, WHITE INJECTION MOLDED, SELF SUSTAINING CHECK HINGES, ANTI-MICROBIAL AGENT.
										SUPPORT: COMMERCIAL GRADE WATER CLOSET CARRIER.

	PLUMBING DRAIN AND CLEANOUT SCHEDULE							
ID	FIXTURE		WASTE		DETAIL /	DESCRIPTION / REMARKS		
.5	T DATE	DFU	TRAP	VENT	SHEET			
<u>FD-1</u>	FLOOR DRAIN (ROUND)	2 3 4	2" 3" 4"	1 1/2" 1 1/2" 2"		FIXTURE: ZURN ZN415-B, CAST IRON BODY, 6" DIAMETER NICKEL BRONZE STRAINER, COMBINATION INVERTIBLE MEMBRANE CLAMP, AND ADJUSTABLE COLLAR.		
<u>FD-2</u>	FLOOR DRAIN (ROUND, HEAVY DUTY)	2 3 4	2" 3" 4"	1 1/2" 1 1/2" 2"		FIXTURE: ZURN ZN508, CAST IRON BODY, 9" DIAMETER NICKEL BRONZE TOP, SEEPAGE PAN, COMBINATION MEMBRANE FLASHING CLAMP & FRAME, AND HEAVY DUTY DEEP FLANGE SLOTTED GRATE.		
<u>HD-1</u>	HUB DRAIN - AT GRADE	3 4 6	2" 3" 4"	1 1/2" 1 1/2" 2"		EXTEND HUB 2" (MIN) ABOVE FLOOR, INSTALL PIPE INCREASER ONE PIPE SIZE LARGER MINIMUM.		
<u>RD-1</u>	ROOF DRAIN					FIXTURE: ZURN ZC100-C-EA-R ROOF DRAIN, CAST IRON BODY, 15" DIA, COMBINATION MEMBRANE FLASHING CLAMP/GRAVEL GUARD, UNDERDECK CLAMP, ADJUSTABLE EXTENSION, ROOF SUMP RECEIVER, AND CAST IRON STRAINER.		
						FINISHED AREAS WITH HARD FLOORS: ZURN ZN1400-BP, CAST IRON, ADJUSTABLE FLOOR CLEANOUT WITH NICKEL BRONZE TOP AND BRONZE PLUG.		
<u>FCO</u>	FLOOR CLEANOUT					FINISHED AREAS WITH CARPETED FLOORS: ZURN ZN1400-BP-CM, CAST IRON, ADJUSTABLE FLOOR CLEANOUT WITH NICKEL BRONZE TOP AND BRONZE PLUG, WITH CARPET MARKER.		
						UNFINISHED AREAS: ZURN ZN1400-BP, CAST IRON, ADJUSTABLE FLOOR CLEANOUT WITH NICKEL BRONZE TOP AND BRONZE PLUG.		
<u>wco</u>	WALL CLEANOUT					FIXTURE: ZURN ZS1468, POLISHED STAINLESS STEEL, ROUND ACCESS COVER, SECURING SCREW & BRONZE RAISED HEX HEAD PLUG. VERIFY LENGTH OF SCREW REQUIRED WITH WALL CONSTRUCTION.		
<u>YCO</u>	YARD CLEANOUT					FIXTURE: 4" PIPE RISER WITH PLUMBING CREATION CI-48-6 FROST SLEEVE OR 6" PIPE RISER WITH PLUMBING CREATION CI-48-8 FROST SLEEVE EXTENDING 5 FEET BELOW FINISHED GRADE.		



ENGINEERING, INC. 5525 NOBEL DRIVE SUITE 110 MADISON, WI 53711 PH: 608.277.1728 FAX: 608.271.7046 JDR PROJECT NO: 23.0319

# WARNER PARK COMMUNITY RECREATION CENTER EXPANSION

1625 NORTHPORT DRIVE MADISON, WI 53704 CITY OF MADISON PARKS DIVISION 330 EAST LAKESIDE STREET MADISON, WI 53715

PROJECT NUMBER

223471.00

ISSUED FOR:

BID SET

REVISION FOR:

CHECKED BY


NO. DESCRIPTION 1 Addendum #2

DATE 6/13/2024


5/16/2024

SCHEDULES - PLUMBING


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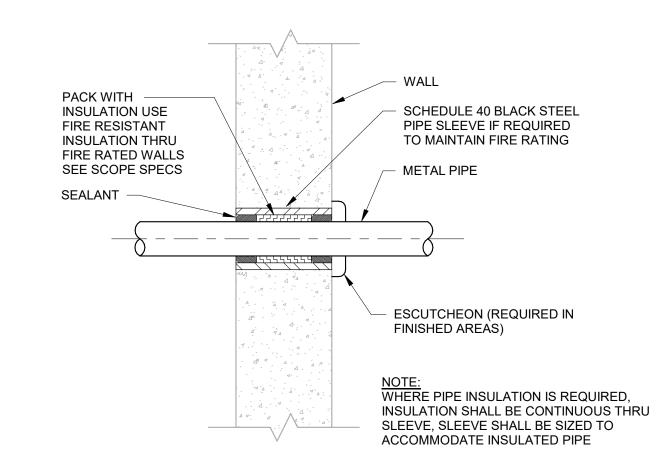

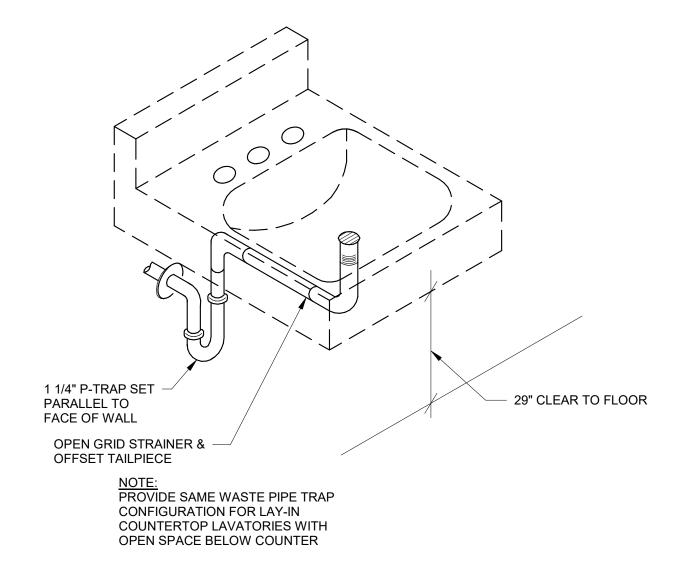
# 4 WALL HUNG LAVATORY - BARRIER FREE P901 SCALE: NONE

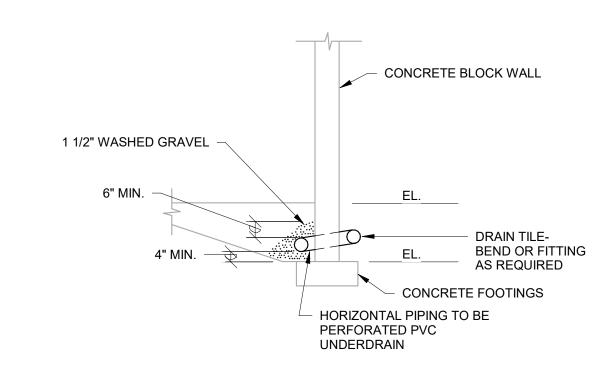


# 5 SECTION THRU DRAIN TILE P901 SCALE: NONE




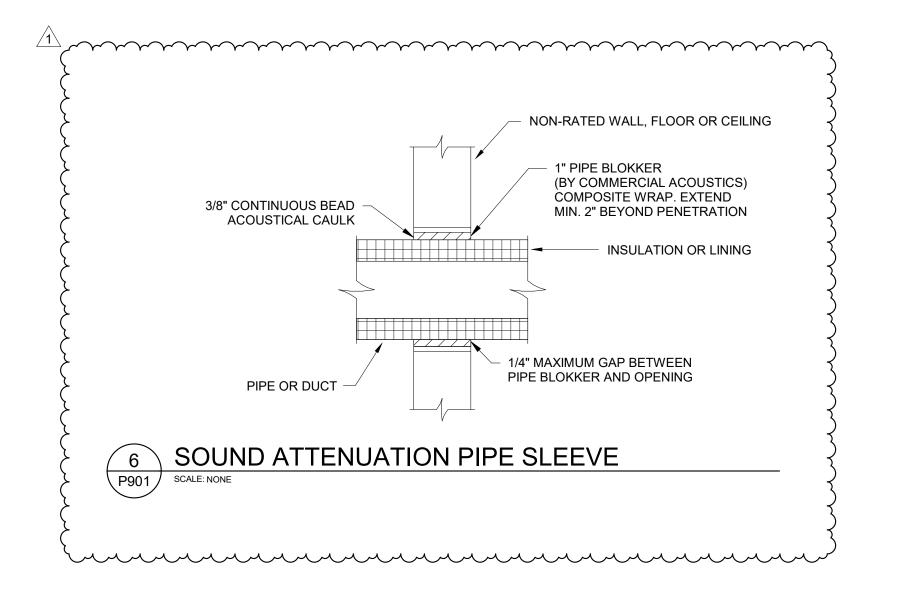

1 SLEEVE THRU WALL DETAIL
P901 SCALE: NONE

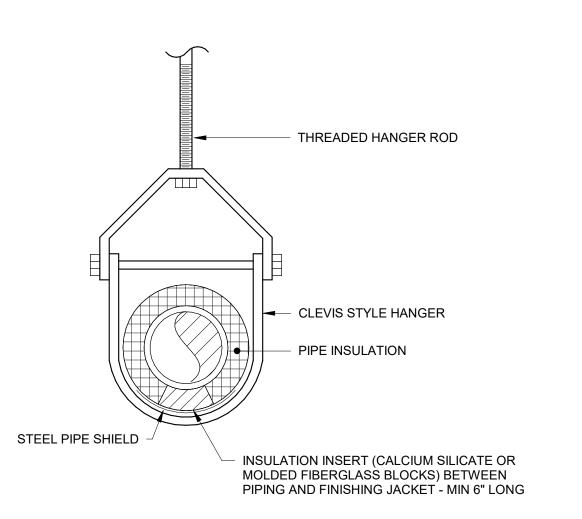



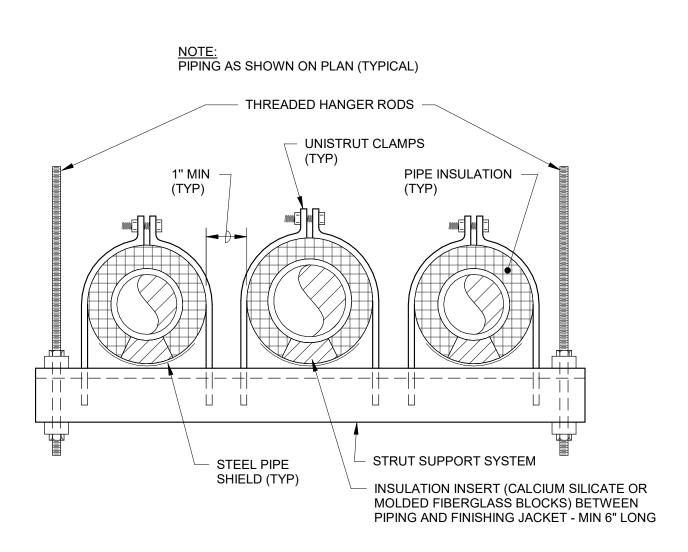





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# WARNER PARK COMMUNITY RECREATION CENTER EXPANSION

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JDR PROJECT NO: 23.0319

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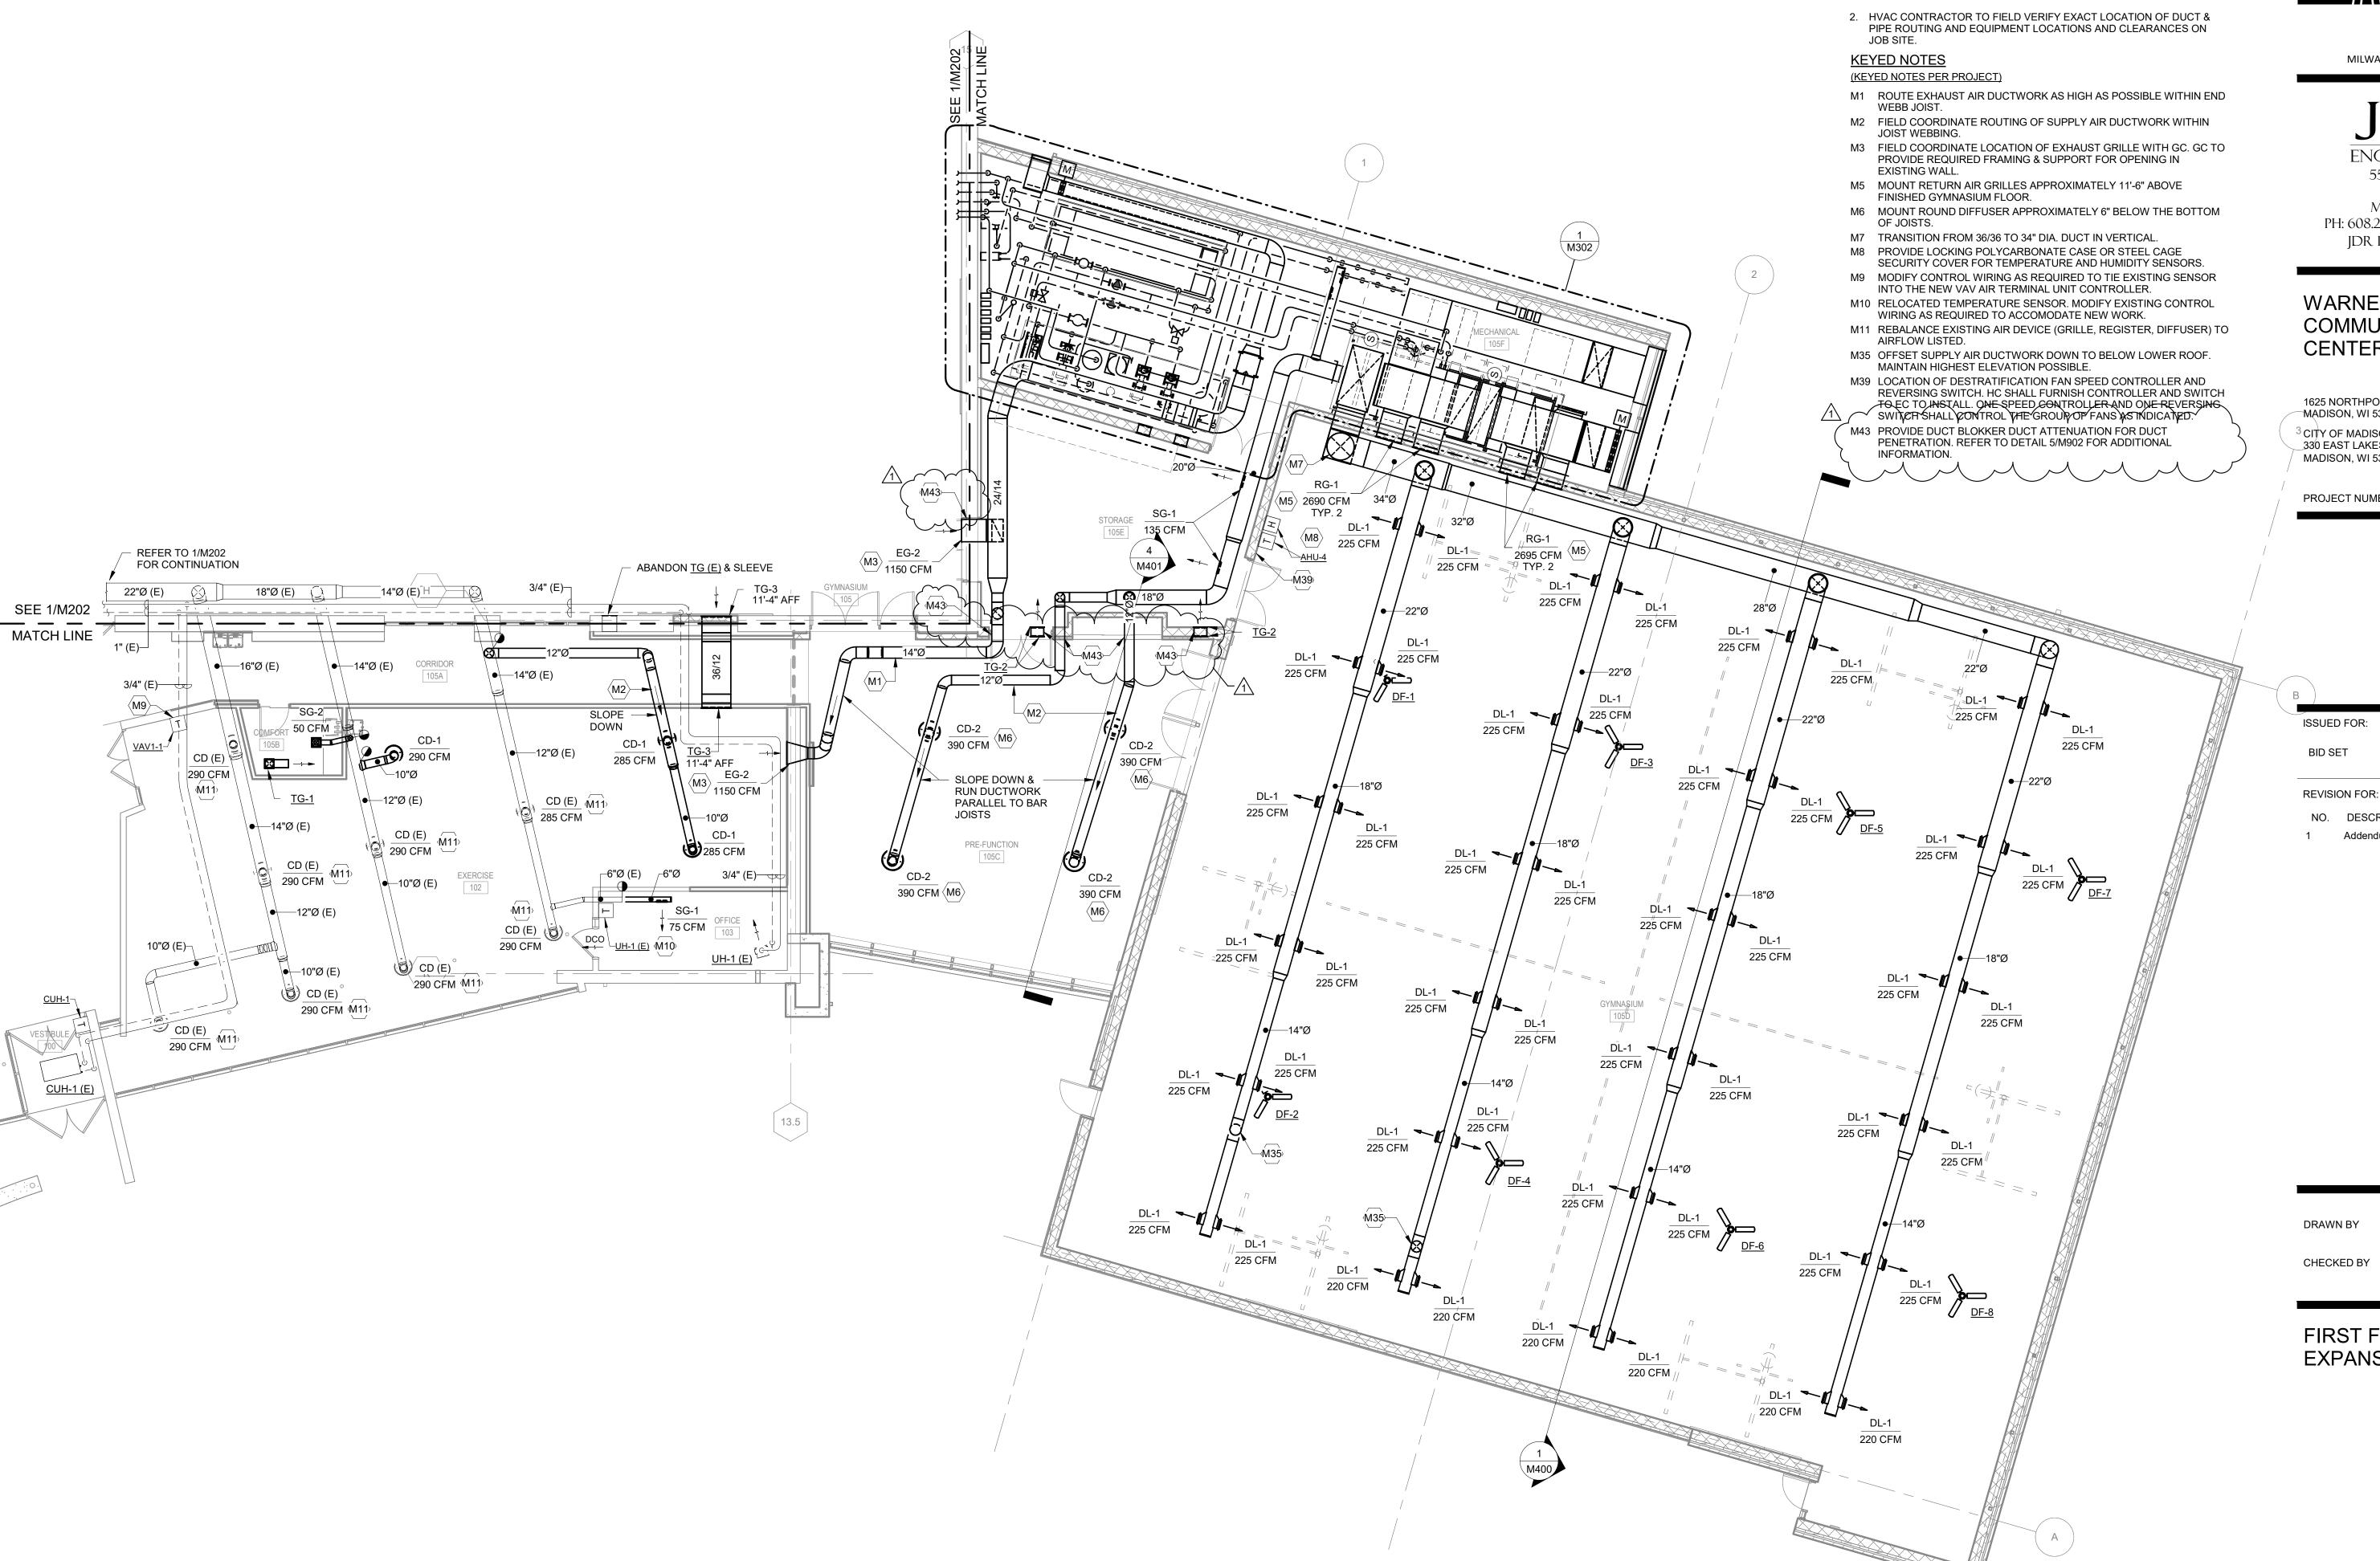
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ISSUE	ED FOR:	
BID	SET	5/16/2024
REVIS	SION FOR:	
NO. 1	DESCRIPTION Addendum #2	DATE 6/13/2024

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DETAILS - PLUMBING





**GENERAL NOTES:** 

JOIST LAYOUT WHERE REQUIRED.

1. COORDINATE ALL DUCT, PIPING, AND EQUIPMENT INSTALLATION WITH

MILWAUKEE | MADISON | CHICAGO

5525 NOBEL DRIVE

SUITE 110 MADISON, WI 53711 PH: 608.277.1728 FAX: 608.271.7046 JDR PROJECT NO: 23.0319

# WARNER PARK COMMUNITY RECREATION CENTER EXPANSION

223471.00

1625 NORTHPORT DRIVE MADISON, WI 53704

<sup>3</sup> CITY OF MADISON PARKS DIVISION \_330 EAST LAKESIDE STREET MADISON, WI 53715

PROJECT NUMBER

ISSUED FOR:

05/16/2024 **BID SET** 

NO. DESCRIPTION DATE 6/13/2024 1 Addendum #2

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PROJECT NORTH

FIRST FLOOR **EXPANSION PLAN - HVAC** 

RCS

**M201** 

## **CHILLER DEMOLITION & REPLACEMENT NOTES:**

1. HVAC CONTRACTOR SHALL PHASE THE DEMOLITION OF THE EXISTING CHILLER AND CHILLED WATER PLANT WITH THE INSTALLATION OF THE NEW HEAT RECOVERY CHILLER PLANT. EXISTING CHILLER AND CHILLED WATER PLANT SHALL REMAIN OPERATIONAL TO LIMIT DOWNTIME OF COOLING TO THE FACILITY.

#### **GENERAL NOTES:**

- 1. COORDINATE ALL DUCT, PIPING, AND EQUIPMENT INSTALLATION WITH JOIST LAYOUT WHERE REQUIRED.
- 2. HVAC CONTRACTOR TO FIELD VERIFY EXACT LOCATION OF DUCT & PIPE ROUTING AND EQUIPMENT LOCATIONS AND CLEARANCES ON JOB SITE.

#### KEYED NOTES (KEYED NOTES PER PROJECT)

INFORMATION.

- M27 4" CONCRETE EQUIPMENT PAD BY GC. HC TO COORDINATE SIZE AND LOCATION.
- M28 6" GEOTHERMAL BOREFIELD MANIFOLDS. REFER TO DETAIL 3/M902 FOR ADDITIONAL REQUIREMENTS.
- M29 PROVIDE 72/76 INSULATED PLENUM FOR OUTSIDE AIR INTAKE, 72/76 INSULATED PLENUM FOR RELIEF AIR, AND PROVIDE INSULATED BLANK-OFF PANELS FOR UN-USED PORTIONS OF LOUVER.
- M30 COORDINATE WITH EC TO PROVIDE 120/1 POWER AND DATA CONNECTION TO TEMPERATURE CONTROL PANEL.
- M31 PROVIDE CONDENSATE LOOP SEAL AND ROUTE CONDENSATE TO HUB DRAIN. CONDENSATE PIPE SIZE SHALL NOT BE SMALLER THAN UNIT CONNECTION SIZE. HUB DRAIN BY PC.
- M34 DUCT MOUNTED SMOKE DETECTOR BY EC.
- M38 LINE ALL RETURN AIR DUCTWORK ASSOCIATED WITH AHU-4. DUCT SIZES SHOWN ARE INSIDE DUCT DIMENSIONS.
- M40 PROVIDE PIPE BLOKKER PIPE ATTENUATION FOR PIPE PENETRATION. REFER TO DETAIL 5/M902 FOR ADDITIONAL
- M41 FIELD COORINATE GEOTHERMAL FIELD PIPING WITH STORM PIPING. REFER TO CIVIL PLANS FOR ADDITIONAL INFORMATION. M43 PROVIDE DUCT BLOKKER DUCT ATTENUATION FOR DUCT PENETRATION. REFER TO DETAIL 5/M902 FOR ADDITIONAL

Engberg Anderson
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ENGINEERING, INC.

5525 NOBEL DRIVE

SUITE 110 MADISON, WI 53711 PH: 608.277.1728 FAX: 608.271.7046 JDR PROJECT NO: 23.0319

# WARNER PARK COMMUNITY RECREATION **CENTER EXPANSION**

223471.00

1625 NORTHPORT DRIVE MADISON, WI 53704 CITY OF MADISON PARKS DIVISION 330 EAST LAKESIDE STREET


PROJECT NUMBER


MADISON, WI 53715


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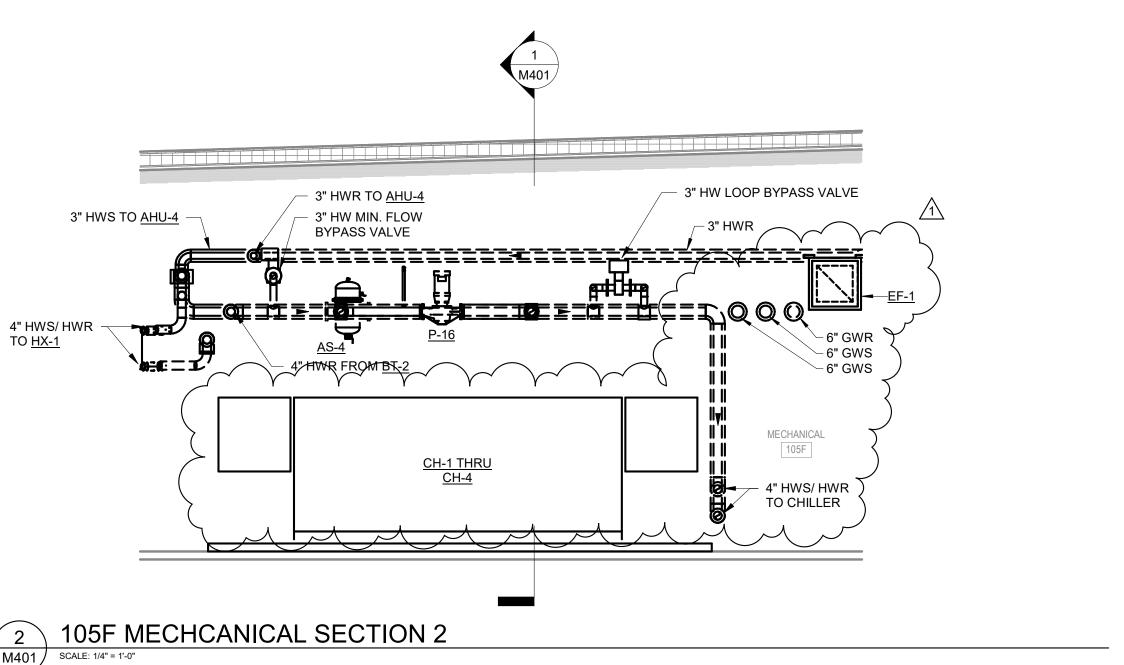
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**ENLARGED MECHANICAL ROOM PLAN - HVAC** M302





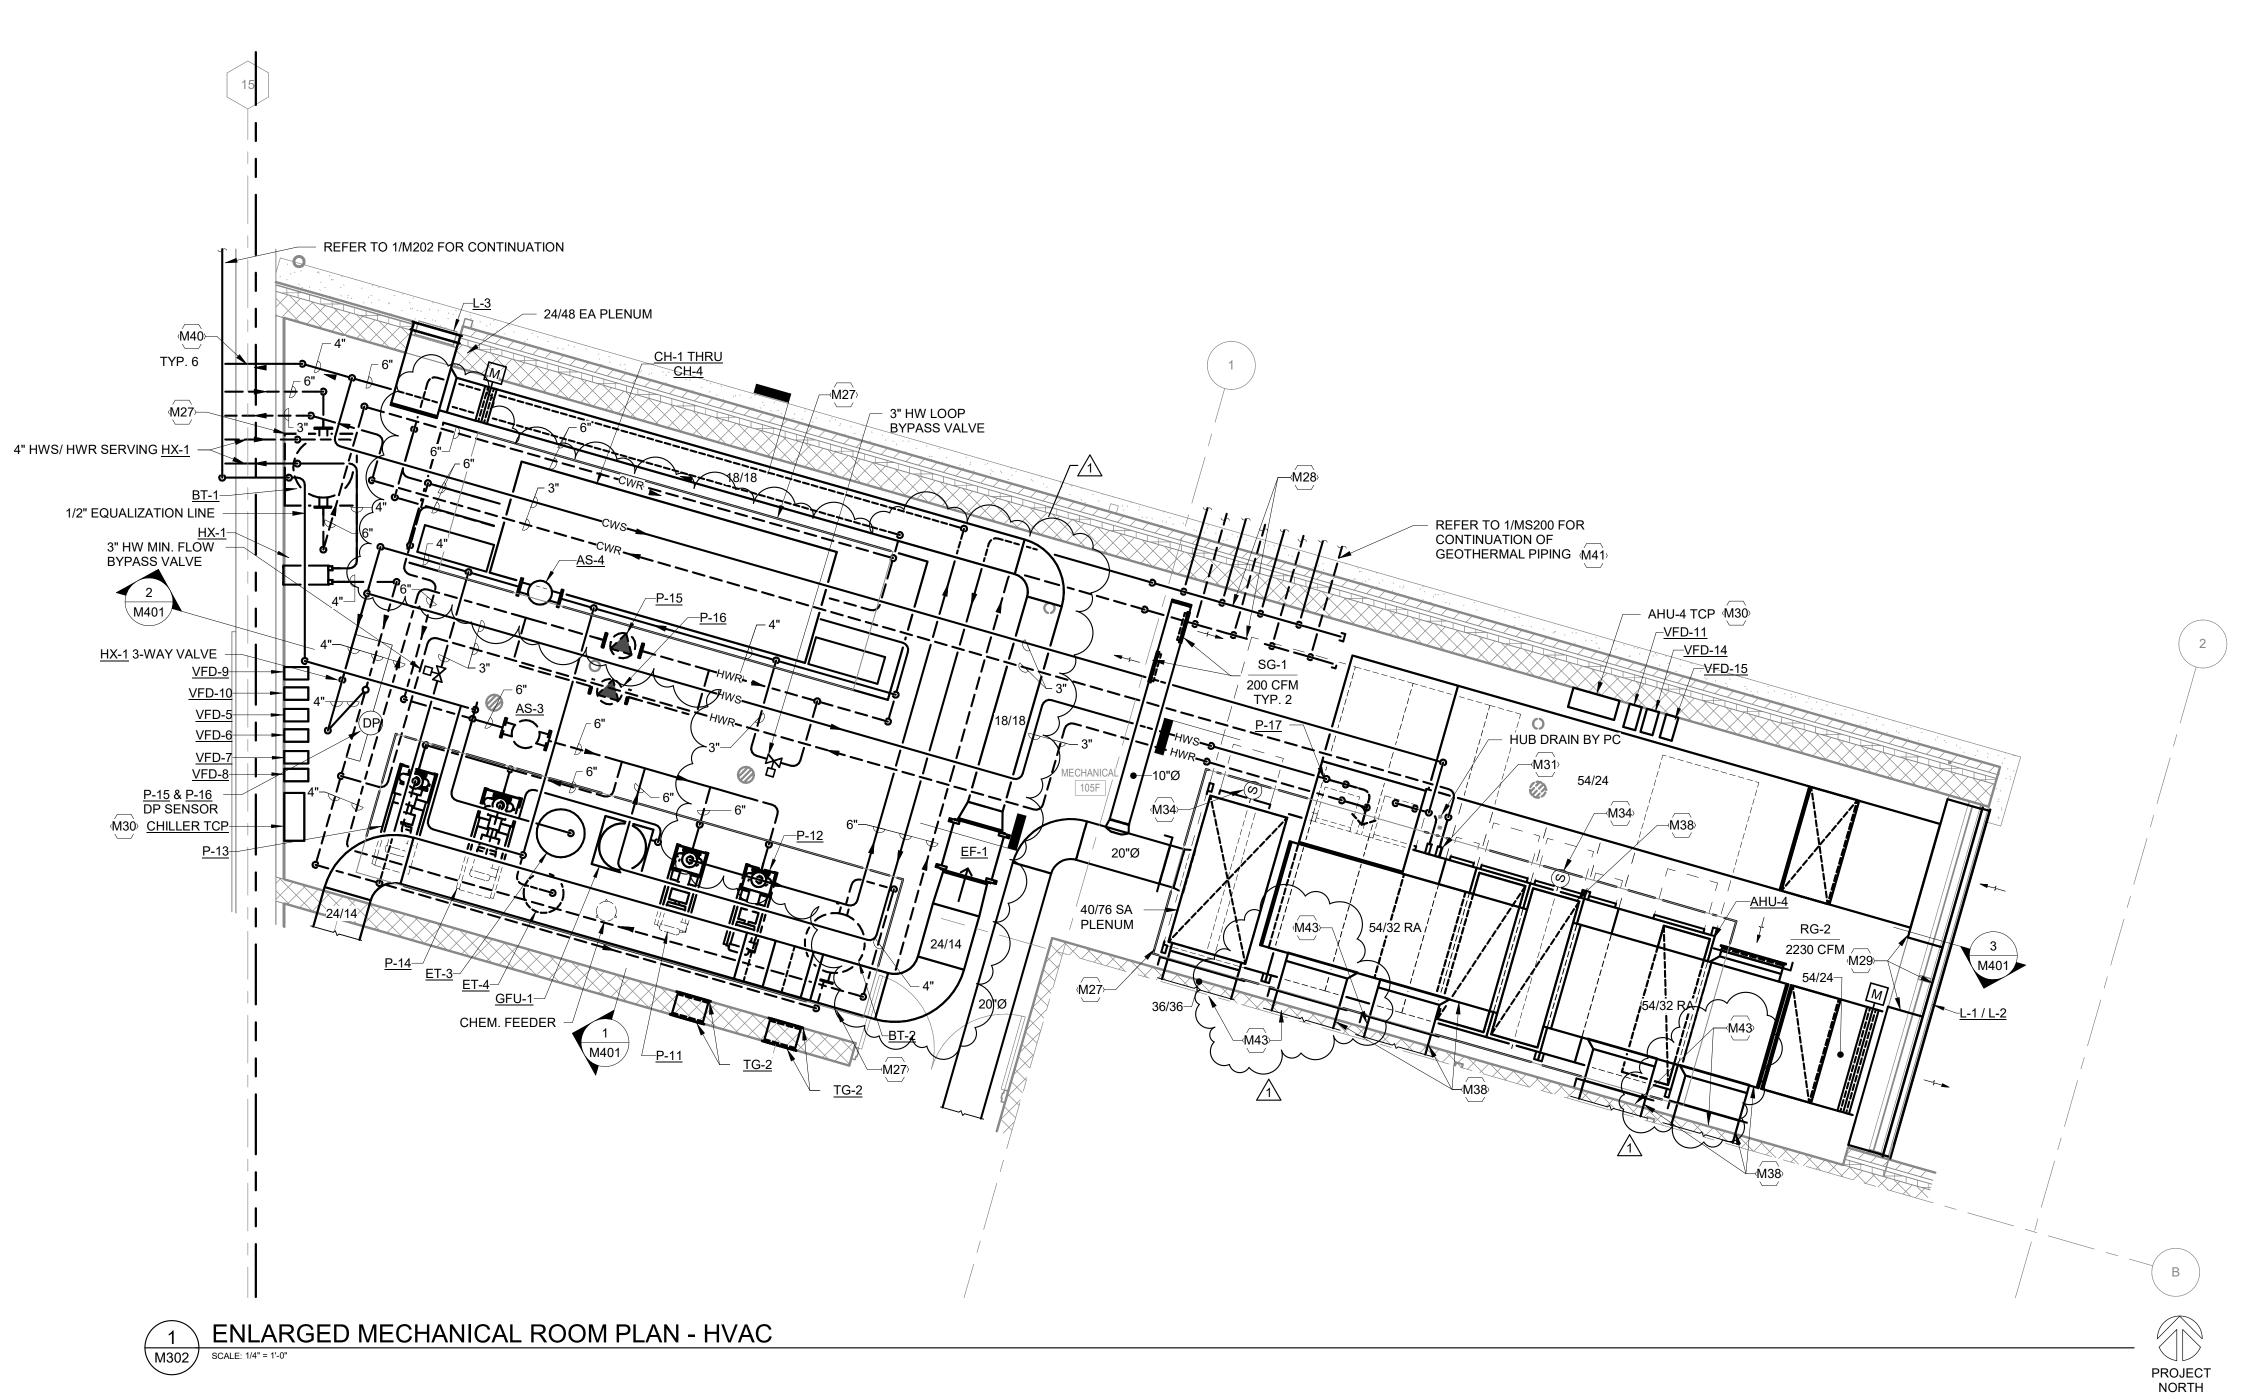

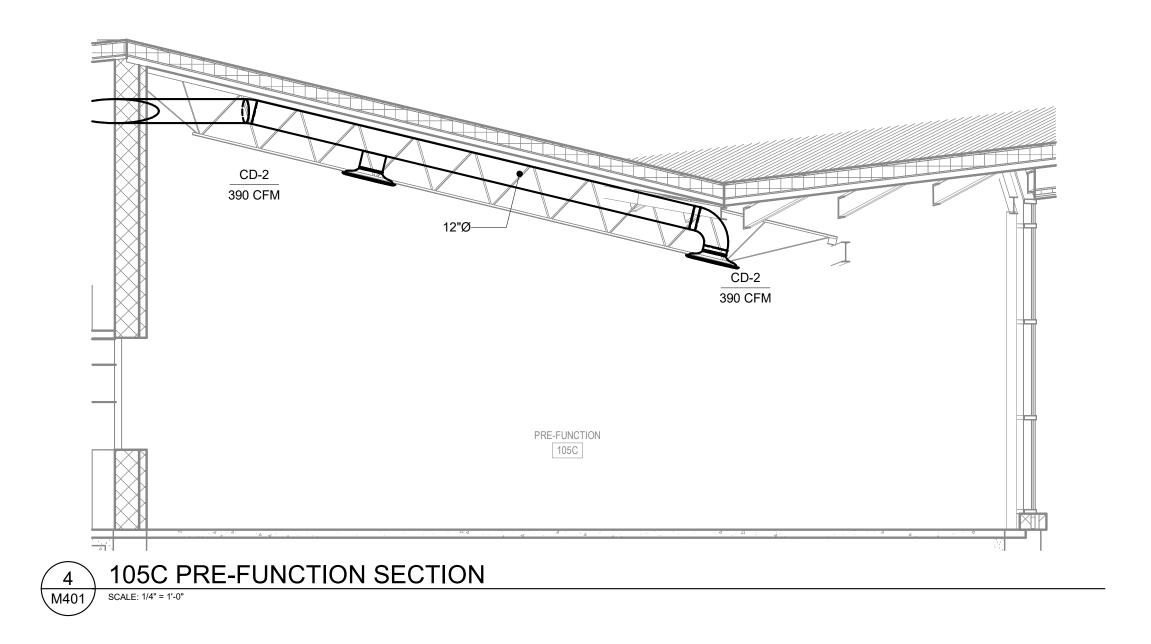

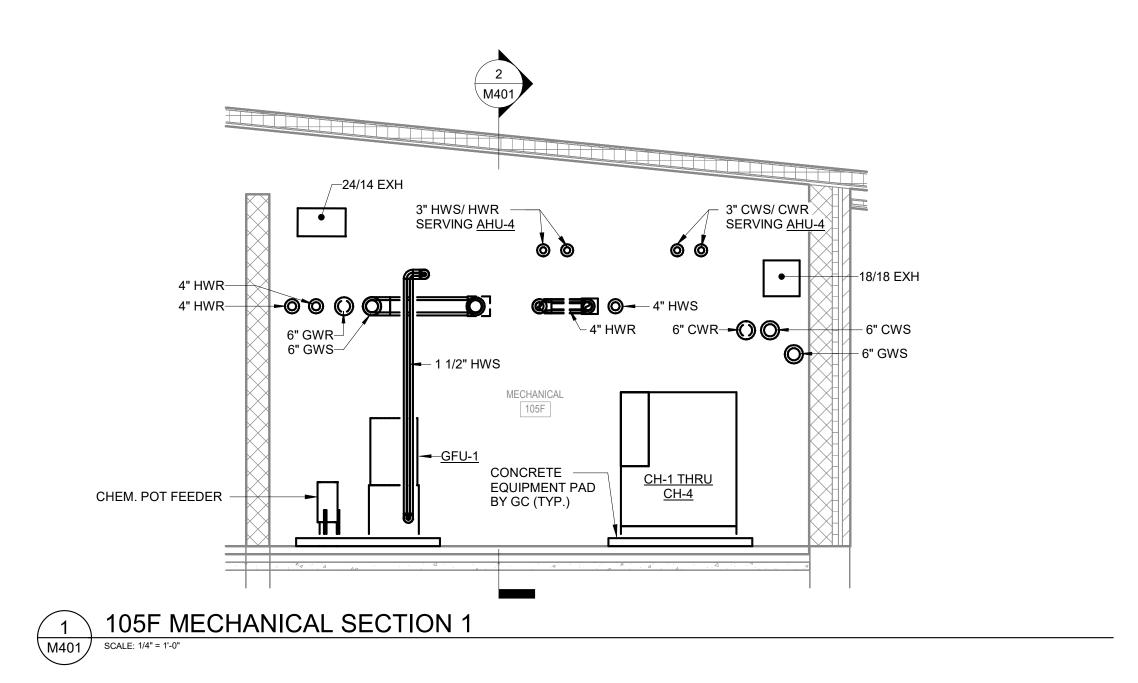

ENGINEERING, INC.
5525 NOBEL DRIVE

SUITE 110 MADISON, WI 53711 PH: 608.277.1728 FAX: 608.271.7046 JDR PROJECT NO: 23.0319

# WARNER PARK COMMUNITY RECREATION CENTER EXPANSION

1625 NORTHPORT DRIVE MADISON, WI 53704 CITY OF MADISON PARKS DIVISION 330 EAST LAKESIDE STREET MADISON, WI 53715


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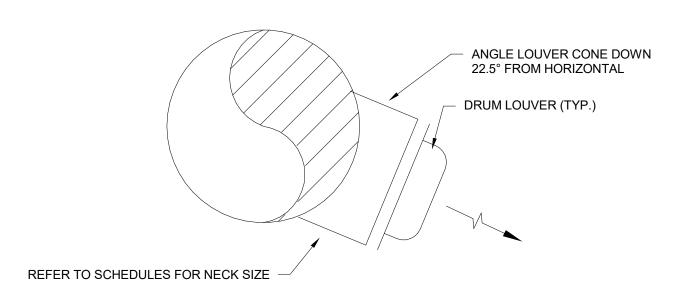
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NO. 1	DESCRIPTION Addendum #2	DATE 6/13/2024

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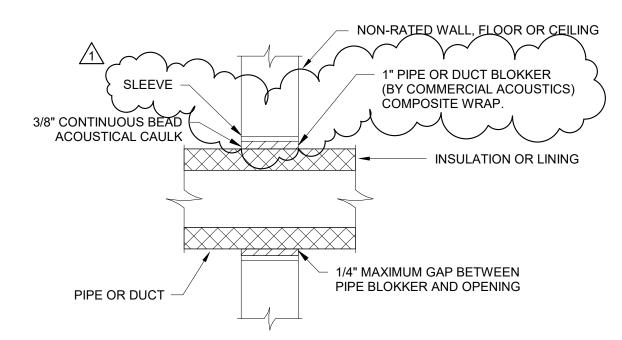
SECTIONS - HVAC






NOTE: PAINT ALL VISIBLE INTERIOR SURFACES OF DUCTWORK FLAT BLACK.

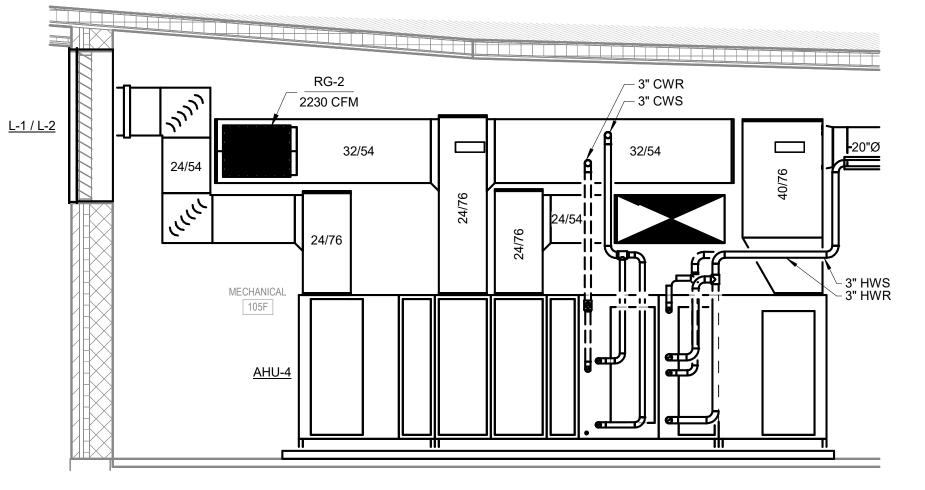
# DRUM LOUVER DETAIL M902 SCALE: NONE




5 SOUND ATTENUATION PIPE OR DUCT SLEEVE
M902 SCALE: NONE

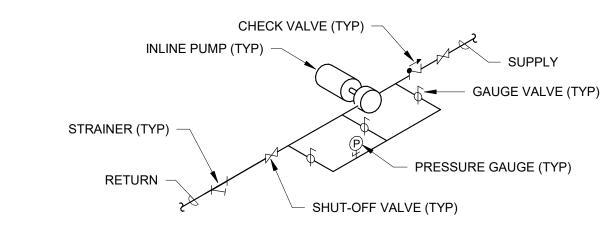


6 INLINE PUMP (SINGLE) DETAIL
M902 SCALE: 12" = 1'-0"

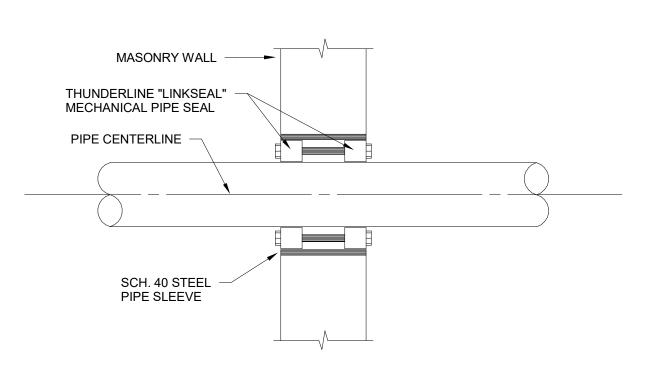


7 EXTERIOR WALL PIPE PENETRATION DETAIL
M902 SCALE: 12" = 1'-0"

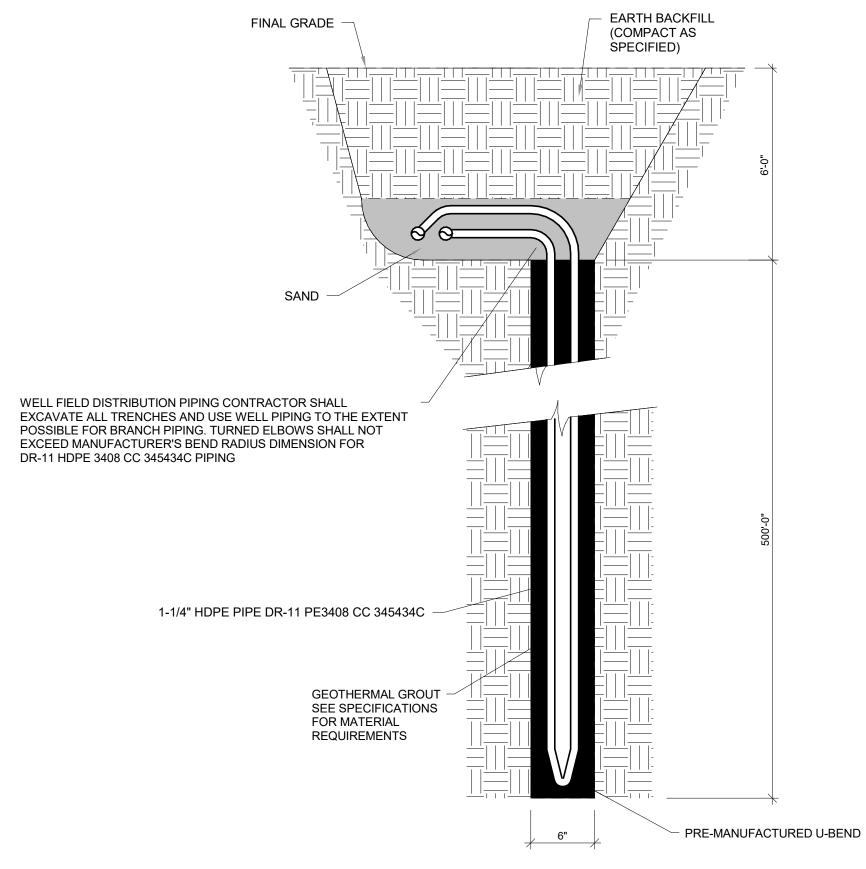

1 GEOTHERMAL VERTICAL HEAT EXCHANGER DETAIL
M902 SCALE: NONE

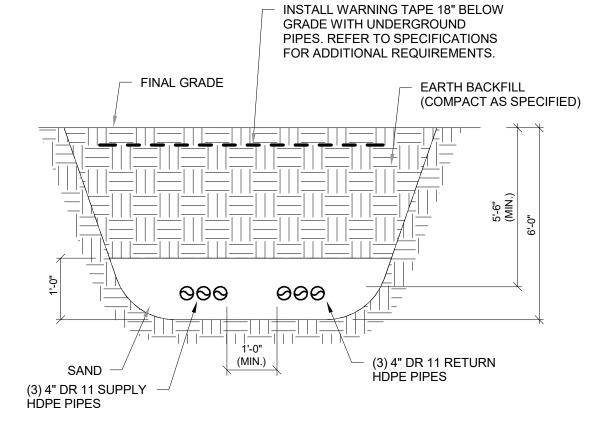



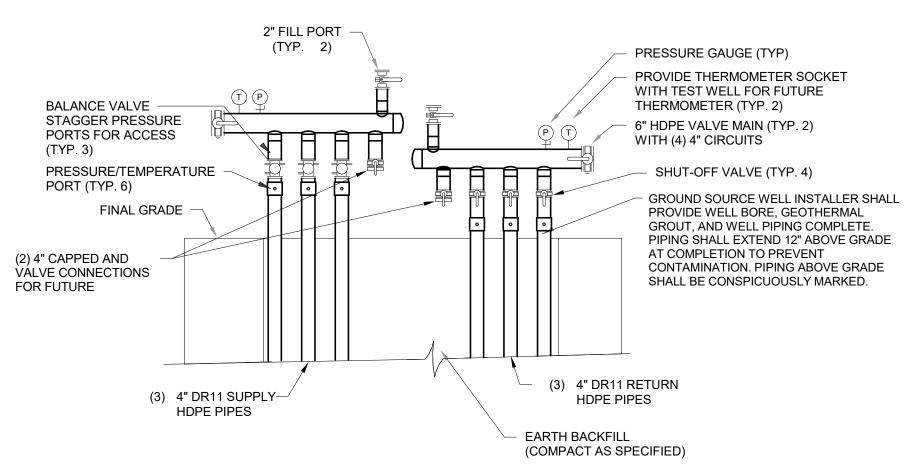

3 GEOTHERMAL MANIFOLD DETAIL
M902 SCALE: NONE



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ENGINEERING, INC. 5525 NOBEL DRIVE

SUITE 110 MADISON, WI 53711 PH: 608.277.1728 FAX: 608.271.7046 JDR PROJECT NO: 23.0319

# WARNER PARK COMMUNITY RECREATION CENTER EXPANSION

223471.00

6/13/2024

1625 NORTHPORT DRIVE MADISON, WI 53704 CITY OF MADISON PARKS DIVISION

330 EAST LAKESIDE STREET MADISON, WI 53715

PROJECT NUMBER

1 Addendum #2

ISSUED FOR:

BID SET 05/16/2024

REVISION FOR:

NO. DESCRIPTION DATE

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**DETAILS - HVAC** 

M902





ENGINEERING, INC. 5525 NOBEL DRIVE SUITE 110 MADISON, WI 53711

PH: 608.277.1728 FAX: 608.271.7046 JDR PROJECT NO: 23.0319

WARNER PARK COMMUNITY RECREATION **CENTER EXPANSION** 

1625 NORTHPORT DRIVE MADISON, WI 53704 CITY OF MADISON PARKS DIVISION

330 EAST LAKESIDE STREET MADISON, WI 53715

PROJECT NUMBER

223471.00

ISSUED FOR: 5/16/2024 BID SET **REVISION FOR:** NO. DESCRIPTION DATE 6/13/2024 1 Addendum #2

# PROJECT NORTH

CHECKED BY

DRAWN BY

PLAN – POWER AND SYSTEMS

OVERALL FIRST FLOOR

## **SYSTEMS GENERAL NOTES:**

**POWER GENERAL NOTES:** 

ACHIEVE THE CONTROLS SHOWN.

1. REFER TO SHEET E000 FOR ALL SYMBOLS, ABBREVIATIONS, AND DETAILS.

2. THE CONTRACTOR MAY INSTALL UP TO THREE (3) CURRENT CARRYING CONDUCTORS IN A CONDUIT.

VERIFY ALL MOUNTING REJENTS OF DEVICES ABOVE MILLWORK WITH ARCHITECTURAL PLANS

AS SHOWN ON THE PLANS. ANY/ALL EXISTING FIRE ALARM DEVICES, CONTROL PANELS,

LOADINGS ARE BASED ON THWN INSULATION, 40°C AMBIENT WITH DERATINGS FOR TEMPERATURE

AND UP TO THREE (3) CONDUCTORS IN A CONDUIT. CONTACT THE ENGINEER FOR WIRING IN OTHER

NOTE THAT THIS PROJECT CONSISTS OF A COMPLETE REPLACEMENT OF THE FIRE ALARM SYSTEM

ANNUNCIATOR PANELS, CABLING, ETC. SHALL BE DISCONNECTED AND REMOVED COMPLETE. REUSE

OF EXISTING INFRASTRUCTURE (BOXES AND CONDUITS ONLY) IS ACCEPTABLE WHERE SIZED AND

SUPPORTED PROPERLY. THE NEW VOICE FIRE ALARM SYSTEM THROUGHOUT THE BUILDING SHALL

BE INSTALLED, PROGRAMMED, TESTED, COMMISSIONED, AND APPROVED BY THE LOCAL AHJ PRIOR

ALARM DEVICES SHALL BE RECESSED IN EXISTING WALLS/CEILINGS UNLESS INDICATED OTHERWISE.

ANY AND ALL FIRE ALARM CABLING SHALL BE EMT CONDUIT AT A MINIMUM. NO FREE AIR CABLING IS

SURFACE MOUNTED ON EXISTING WALLS/CEILINGS SHALL BE PAINTED TO OWNER'S SATISFACTION.

CONTROLS SHOWN ON THE LIGHTING PLANS. PROVIDE CONTROL DEVICES, ETC. AS REQUIRED TO

TO DECOMMISSIONING AND REMOVING THE EXISTING FIRE ALARM SYSTEM. ANY/ALL NEW FIRE

ALLOWED. ANY/ALL EXISTING BOXES AND CONDUITS WITHIN THE EXISTING BUILDING THAT ARE

REMOVED SHALL HAVE THE EXISTING WALLS/CEILINGS PATCHED AND PAINTED TO OWNER'S

ALL RECEPTACLES WITH PLUGICAD CONTROL SHALL BE CONTROLLABLE WATHELIGHTING

SATISFACTION. ANY/ALL NEW BOXES AND CONDUITS WITHIN THE EXISTING BUILDING THAT ARE

- 1. ALL LOW VOLTAGE CABLES OR CONDUCTORS OPERATING AT LESS THAN 50 VOLTS SHALL BE IN ELECTRICAL METAL TUBING (EMT) WHERE INSTALLED WITHIN WALLS OR INACCESSIBLE SPACES.
- TV OUTLETS, VOLUME CONTROLS, TELEPHONE OUTLETS, AND DATA OUTLETS SHALL CONSIST OF A BACK BOX WITH CONDUIT STUBBED ABOVE THE ACCESSIBLE CEILING, SEE ROUGH-IN DETAIL. VERIFY SIZE OF BACK BOX REQUIRED WITH DEVICE TO BE INSTALLED. LOCATE BACK BOXES 6" FROM ADJACENT POWER RECEPTACLE INTENDED FOR COMPUTER USE.
- ANY/ALL LOW VOLTAGE SYSTEMS, INCLUDING BUT NOT LIMITED TO THE FOLLOWING: COMMUNICATIONS, PAGING, CLOCK SYSTEM, CLASS BELLS, ETC., SHALL BE MAINTAINED THROUGHOUT CONSTRUCTION. FIELD VERIFY ALL LOW VOLTAGE SYSTEM REQUIREMENTS AND EXTEND/MAINTAIN/REUSE AS REQUIRED. EXTEND ANY/ALL NEW COMMUNICATIONS CABLING TO EXISTING MDF/IDF AS REQUIRED. COORDINATE JACK/CABLING REQUIREMENTS AND COLORS WITH OWNER.
- CAMERA MOUNTING SHALL BE COORDINATED WITH OWNER. VERIFY DESIRED MOUNTING HEIGHT AND CAMERA MOUNT TYPE PRIOR TO INSTALL.
- ALL WAP LOCATIONS SHOWN ARE APPROXIMATE. CONFIRM ALL EXACT/FINAL WAP LOCATIONS WITH CITY I.T. DEPARTMENT PRIOR TO ROUGH IN. WAP MOUNTING SHALL BE COORDINATED WITH OWNER. VERIFY
- 6. ALL NEW CAT6 CABLING SHALL BE ROUTED TO STORAGE (TR ROOM) #105E.

**KEYED NOTES** 

(KEYED NOTES PER PROJECT)

HUBBELL #HSQ4836.

LOCATION SHOWN.

S2 FOR CONNECTION OF TELECOM ROOMS, RUN TWELVE STRAND

S3 PROVIDE AND INSTALL NEW LOCKING IT CABINET EQUAL TO

SINGLE MODE FIBER FROM STORAGE (TR ROOM) 123 TO STORAGE

MOUNTED PATCH PANEL IN EACH TR. PROVIDE 12 LC TO LC PATCH

(TR ROOM) 105E. TERMINATE WITH LC CONNECTORS ON CABINET

S5 PROVIDE AND INSTALL (2) 2" CONDUITS ROUTED FROM STORAGE (TR

ROOM) 123 TO STORAGE (TR ROOM) 105E. PROVIDE JUNCTION

APPROXIMATELY AS SHOWN. CONDUITS SHALL BE PAINTED TO

S6 EXISTING KITCHEN HOOD MONITOR MODULE TO BE DISCONNECTED,

REQUIREMENTS WITH EXISTING HOOD/EQUIPMENT AND CONNECT

SPEAKER CABLING FROM PRE-FUNCTION #105C AND GYMNASIUM

CABLING FROM OFFICE #103 (CURRENTLY DAMAGED) SHALL BE ROUTED OVERHEAD TO THIS POINT. EXTEND NEW CABLES TO EXISTING AMP FROM THIS LOCATION.

#105D SHALL BE ROUTED TO THIS POINT. ALL NEW PAGING SPEAKER

REMOVED, AND REPLACED. CONNECT TO NEW FIRE ALARM

S12 FIRE ALARM DEVICE TO BE SURFACE MOUNTED AT APPROXIMATE

S14 PROVIDE A PAGING SPEAKER CABLING TERMINATION POINT (J-BOX AS REQUIRED) ABOVE THE CEILING IN THIS ROOM. ALL NEW PAGING

CONTROL PANEL IN SAME LOCATION. FIELD VERIFY ALL

MATCH EXISTING CEILING/UTILITIES COLOR WHEN ROUTED

THROUGH SPACE(S) WITH NO CEILINGS.

TO NEW FIRE ALARM SYSTEM AS REQUIRED.

BOXES ABOVE CEILING IN WORK ROOM 115 AND IN GYMNASIUM 105

- DESIRED MOUNTING HEIGHT AND WAP MOUNT TYPE PRIOR TO INSTALL.

## **KEYED NOTES**

#### (KEYED NOTES PER PROJECT)

- P1 LOCATE INVERTERS FOR ROOF MOUNTED PV ARRAY AT THIS LOCATION.
- P2 PROVIDE AND INSTALL NEW 208Y/120V, 600A PANEL 'K'.
- P3 PROVIDE AND INSTALL DUAL CONTROLLED RECEPTACLE EQUAL TO LEGRAND #WRC-20-2. PROVIDE CEILING MOUNTED RF TRANSMITTER EQUAL TO LEGRAND #WRC-TX-LM. PROVIDE ROOM
- P4 COORDINATE HEIGHT OF POWER AND DATA FOR SCREEN WITH ARCHITECT.
- P5\_LOCATION-OF DESTRATIFICATION FAN SPEED CONTROLLER AND REVERSING SWITCH, HC SHALL FURNISH CONTROLLER AND SWITCHTO EC TOURSTALL. REFER TO MOOTFOR MORE DETAILS. P6 PROVIDE SOUND ATTENUATION AS REQUIRED AT ANY/ALL WALL PENETRATIONS. REFER TO 10/E900
- FOR MORE DETAIL. S1 / MOUNT SMOKE DETECTOR ABOVE PERFEBATED CEILING.
- FOR CONNECTION OF TELECOM ROOMS, RUN TWELVE STRAND SINGLE MODE FIBER FROM STORAGE (TR ROOM) 123 TO STORAGE (TR ROOM) 105E. TERMINATE WITH LC CONNECTORS ON
- CABINET MOUNTED PATCH PANEL IN EACH TR. PROVIDE 12 LC TO LC PATCH CABLES. S3 PROVIDE AND INSTALL NEW LOCKING IT CABINET EQUAL TO HUBBELL #HSQ4836. S4 EXTEND EXISTING PAGING FEEDS THROUGH OVERHEAD CONDUIT SYSTEM TO THIS LOCATION.
- CONTRACTOR SHALL CUT EXISTING UNDERGROUND FEED AND SPLICE TO NEW OVERHEAD CONDUIT SYSTEM. S5 PROVIDE AND INSTALL (2) 2" CONDUITS ROUTED FROM STORAGE (TR ROOM) 123 TO STORAGE (TR ROOM) 105E. PROVIDE JUNCTION BOXES ABOVE CEILING IN WORK ROOM 115 AND IN GYMNASIUM

105 APPROXIMATELY AS SHOWN. CONDUITS SHALL BE PAINTED TO MATCH EXISTING

CEILING/UTILITIES COLOR WHEN ROUTED THROUGH SPACE(S) WITH NO CEILINGS.

# SYSTEMS GENERAL NOTES:

- ALL LOW VOLTAGE CABLES OR CONDUCTORS OPERATING AT LESS THAN 50 VOLTS SHALL BE IN ELECTRICAL METAL TUBING (EMT) WHERE INSTALLED WITHIN WALLS OR INACCESSIBLE SPACES.
- TV OUTLETS, VOLUME CONTROLS, TELEPHONE OUTLETS, AND DATA OUTLETS SHALL CONSIST OF A BACK BOX WITH CONDUIT STUBBED ABOVE THE ACCESSIBLE CEILING, SEE ROUGH-IN DETAIL. VERIFY SIZE OF BACK BOX REQUIRED WITH DEVICE TO BE INSTALLED. LOCATE BACK BOXES 6" FROM ADJACENT POWER RECEPTACLE INTENDED FOR COMPUTER USE.
- ANY/ALL LOW VOLTAGE SYSTEMS, INCLUDING BUT NOT LIMITED TO THE FOLLOWING: COMMUNICATIONS, PAGING, CLOCK SYSTEM, CLASS BELLS, ETC., SHALL BE MAINTAINED THROUGHOUT CONSTRUCTION. FIELD VERIFY ALL LOW VOLTAGE SYSTEM REQUIREMENTS AND EXTEND/MAINTAIN/REUSE AS REQUIRED. EXTEND ANY/ALL NEW COMMUNICATIONS CABLING TO EXISTING MDF/IDF AS REQUIRED. COORDINATE JACK/CABLING REQUIREMENTS AND COLORS WITH OWNER.
- CAMERA MOUNTING SHALL BE COORDINATED WITH OWNER. VERIFY DESIRED MOUNTING HEIGHT AND CAMERA MOUNT TYPE PRIOR TO INSTALL.
- ALL WAP LOCATIONS SHOWN ARE APPROXIMATE. CONFIRM ALL EXACT/FINAL WAP LOCATIONS WITH CITY I.T. DEPARTMENT PRIOR TO ROUGH IN. WAP MOUNTING SHALL BE COORDINATED WITH OWNER. VERIFY DESIRED MOUNTING HEIGHT AND WAP MOUNT TYPE PRIOR TO INSTALL
- 6. ALL NEW CAT6 CABLING SHALL BE ROUTED TO STORAGE (TR ROOM) #105E.

#### **POWER GENERAL NOTES:**

- 1. REFER TO SHEET E000 FOR ALL SYMBOLS, ABBREVIATIONS, AND DETAILS.
- THE CONTRACTOR MAY INSTALL UP TO THREE (3) CURRENT CARRYING CONDUCTORS IN A CONDUIT. LOADINGS ARE BASED ON THWN INSULATION, 40°C AMBIENT WITH DERATINGS FOR TEMPERATURE AND UP TO THREE (3) CONDUCTORS IN A CONDUIT. CONTACT THE ENGINEER FOR WIRING IN OTHER

## VERIEVALL MOUNTING HEIGHTS OF DEVICES ABOVE MILLWORK WITH ARCHITECTURAL PLANS.

NOTE THAT THIS PROJECT CONSISTS OF A COMPLETE REPLACEMENT OF THE FIRE ALARM SYSTEM AS SHOWN ON THE PLANS. ANY/ALL EXISTING FIRE ALARM DEVICES, CONTROL PANELS, ANNUNCIATOR PANELS, CABLING, ETC. SHALL BE DISCONNECTED AND REMOVED COMPLETE. REUSE OF EXISTING INFRASTRUCTURE (BOXES AND CONDUITS ONLY) IS ACCEPTABLE WHERE SIZED AND SUPPORTED PROPERLY. THE NEW VOICE FIRE ALARM SYSTEM THROUGHOUT THE BUILDING SHALL BE INSTALLED, PROGRAMMED, TESTED, COMMISSIONED, AND APPROVED BY THE LOCAL AHJ PRIOR TO DECOMMISSIONING AND REMOVING THE EXISTING FIRE ALARM SYSTEM. ANY/ALL NEW FIRE ALARM DEVICES SHALL BE RECESSED IN EXISTING WALLS/CEILINGS UNLESS INDICATED OTHERWISE. ANY AND ALL FIRE ALARM CABLING SHALL BE EMT CONDUIT AT A MINIMUM. NO FREE AIR CABLING IS ALLOWED. ANY/ALL EXISTING BOXES AND CONDUITS WITHIN THE EXISTING BUILDING THAT ARE REMOVED SHALL HAVE THE EXISTING WALLS/CEILINGS PATCHED AND PAINTED TO OWNER'S SATISFACTION. ANY/ALL NEW BOXES AND CONDUITS WITHIN THE EXISTING BUILDING THAT ARE SURFACE MOUNTED ON EXISTING WALLS/CEILINGS SHALL BE PAINTED TO OWNER'S SATISFACTION.

ALL RECEPTACTES WITH PLUCE(OAD CONTROL SHALL BE CONTROLLABLE VIA THE LICHTING ` CONTROLS SHOWN ON THE LIGHTING PLANS. PROVIDE CONTROL DEVICES, ETC. AS REQUIRED TO ACHIEVE THE CONTROLS SHOWN.



MILWAUKEE | MADISON | CHICAGO

5525 NOBEL DRIVE

SUITE 110 MADISON, WI 53711 PH: 608.277.1728 FAX: 608.271.7046 JDR PROJECT NO: 23.0319

# WARNER PARK COMMUNITY RECREATION **CENTER EXPANSION**

223471.00

1625 NORTHPORT DRIVE MADISON, WI 53704 CITY OF MADISON PARKS DIVISION 330 EAST LAKESIDE STREET

PROJECT NUMBER


MADISON, WI 53715


ISSUED FOR: **BID SET** 5/16/2024 **REVISION FOR:** NO. DESCRIPTION DATE 6/13/2024 1 Addendum #2

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PARTIAL FIRST FLOOR PLAN – POWER AND SYSTEMS

E201



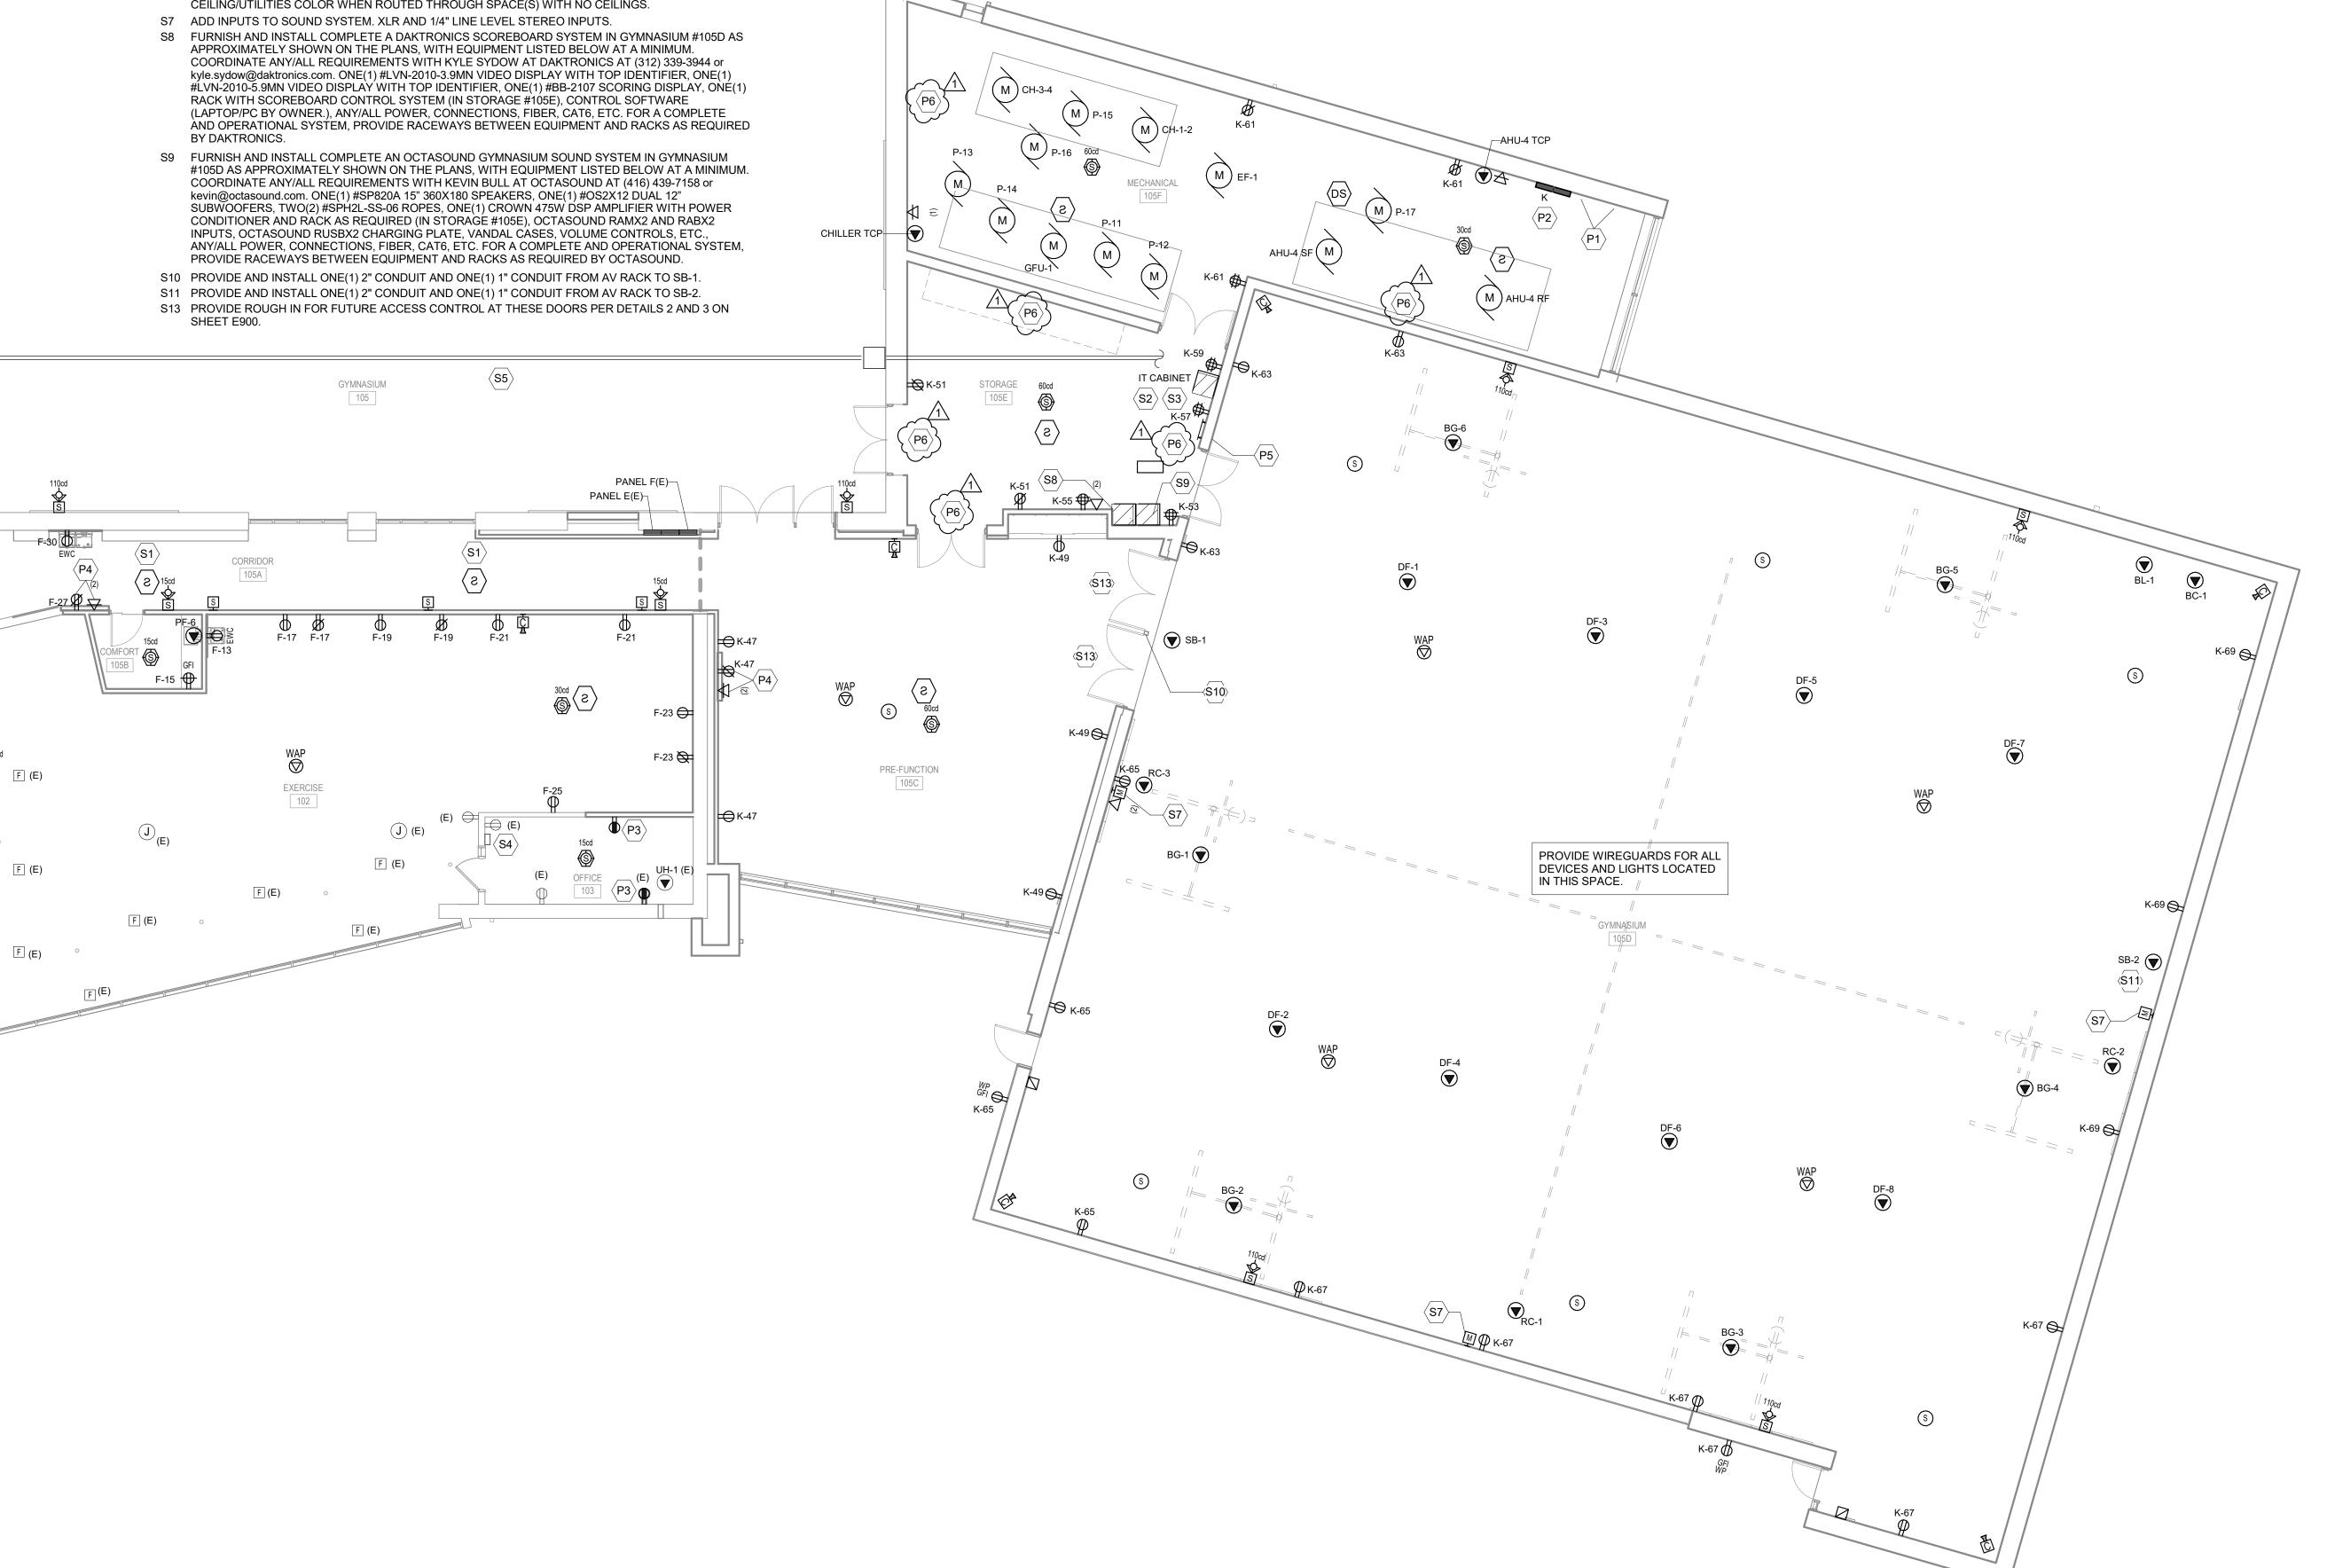

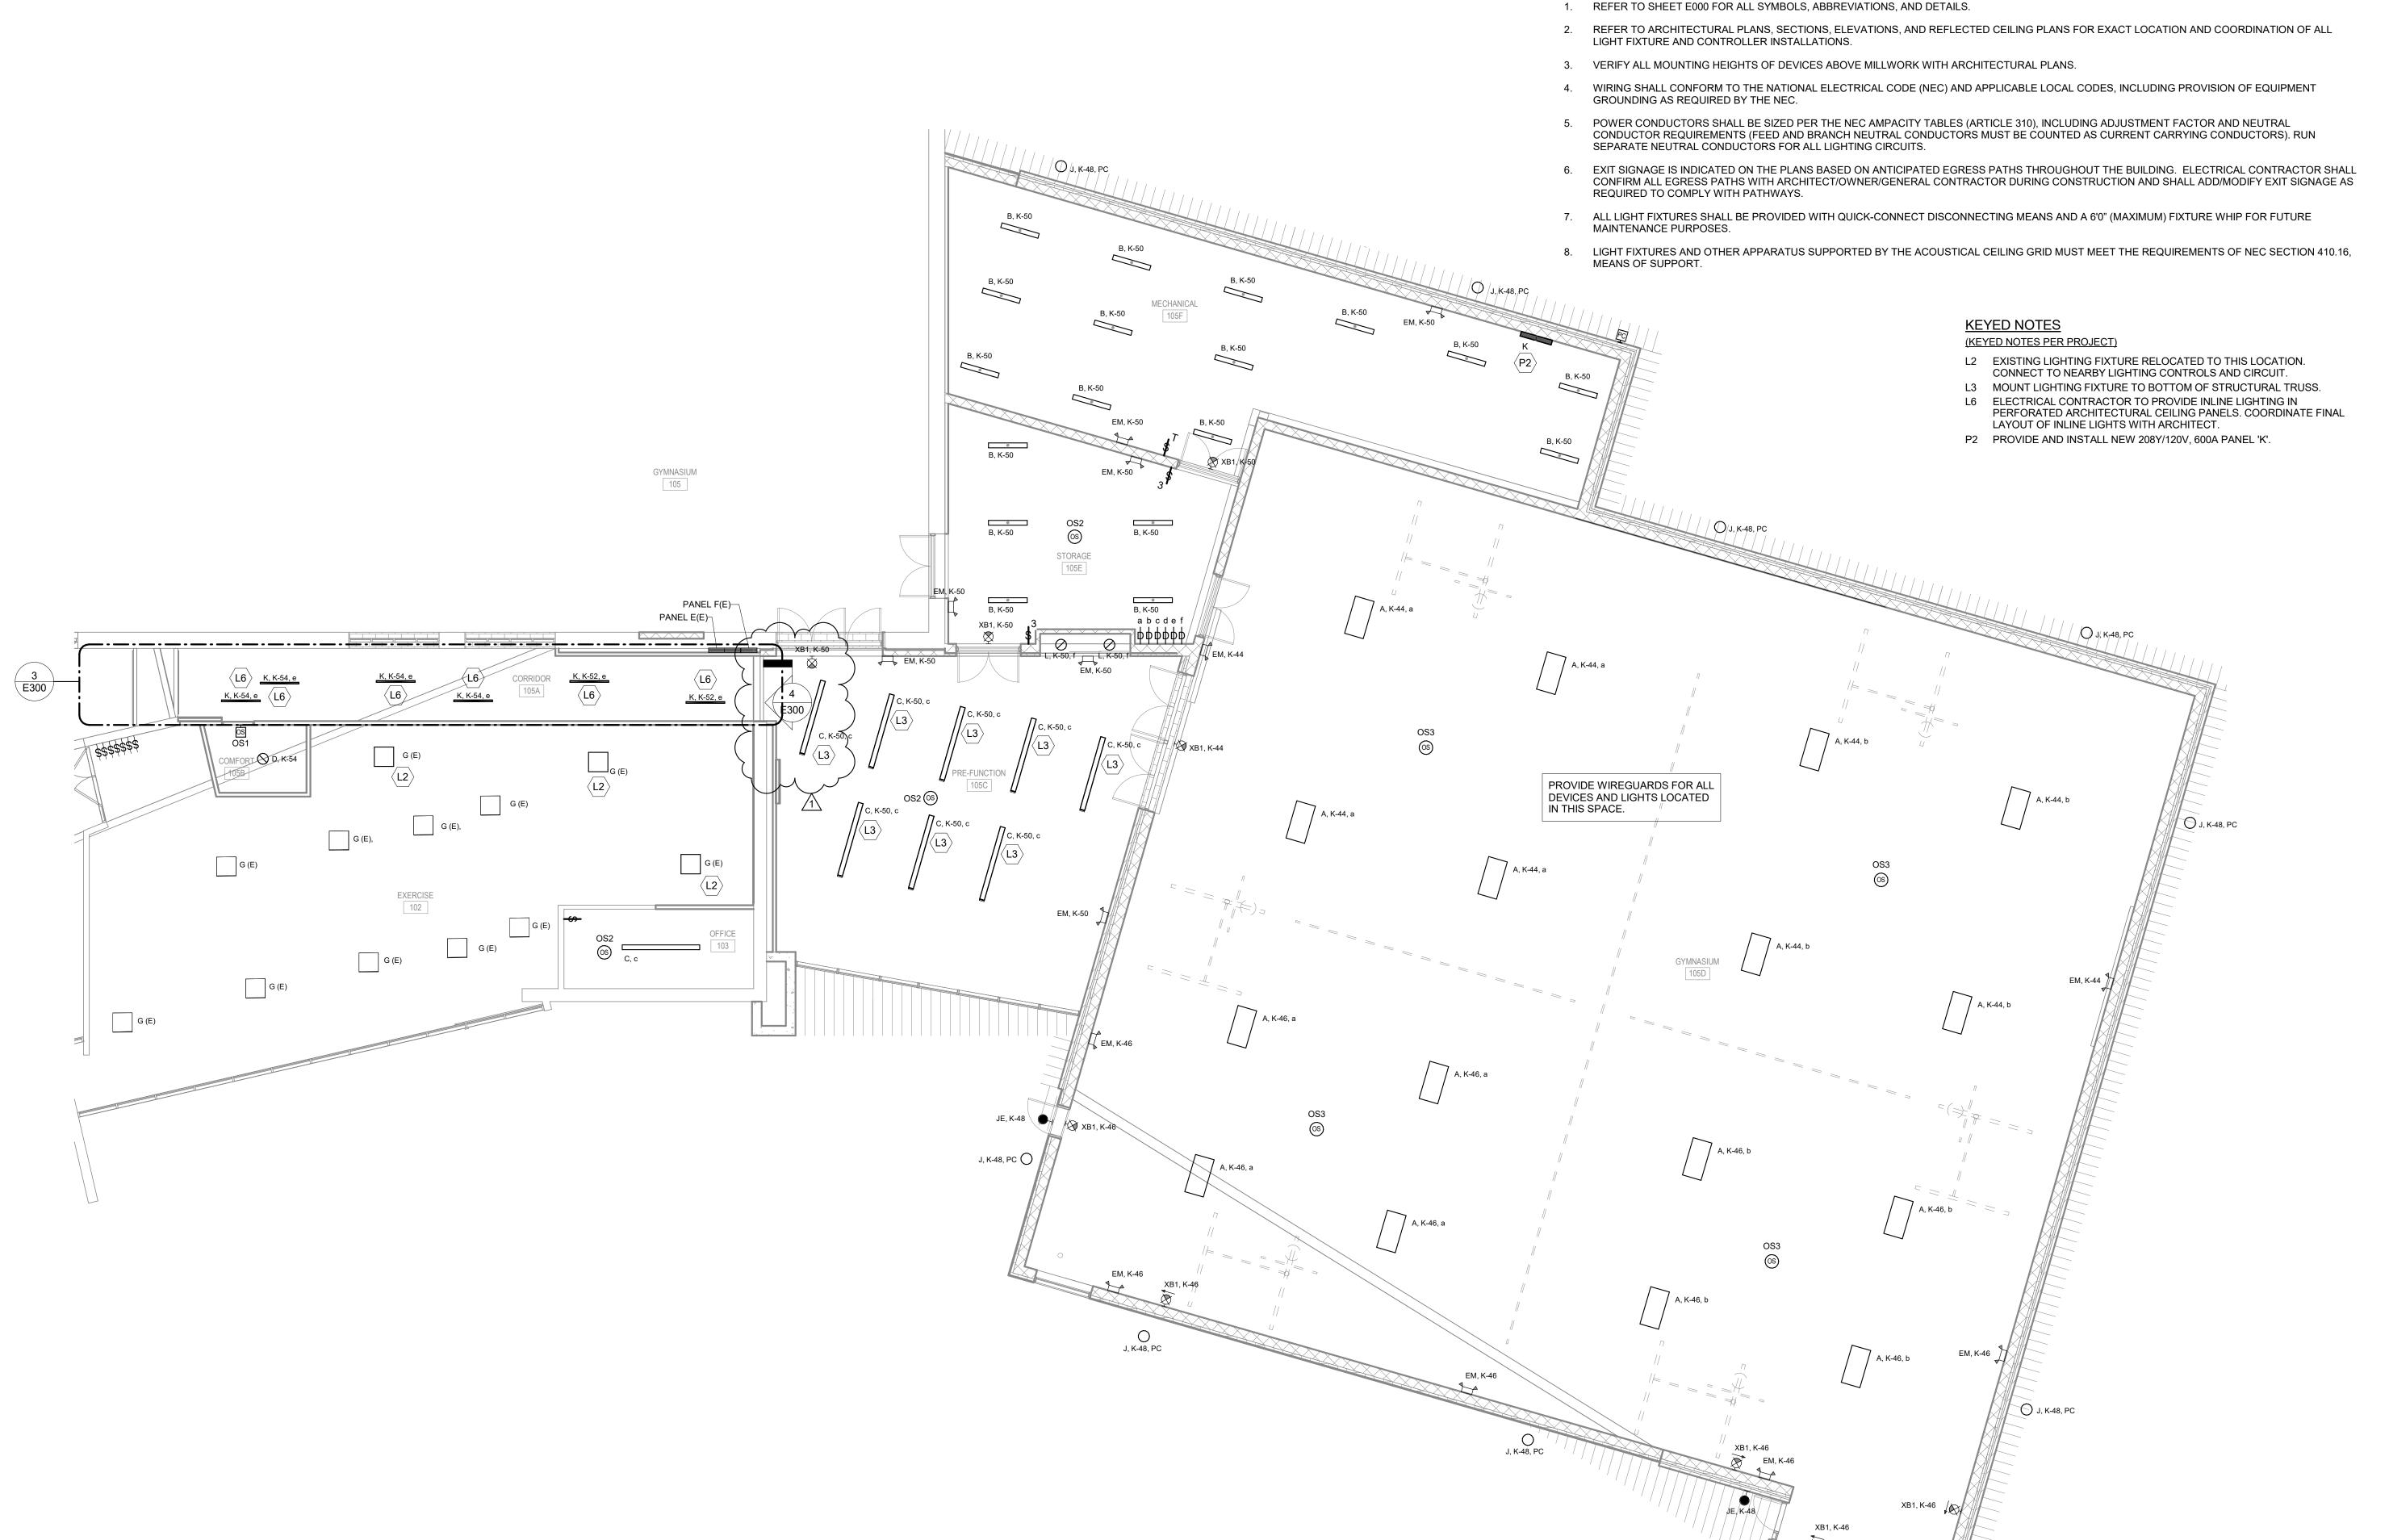**LIGHTING GENERAL NOTES:** 



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JDR ENGINEERING, INC. 5525 NOBEL DRIVE

SUITE 110 MADISON, WI 53711 PH: 608.277.1728 FAX: 608.271.7046 JDR PROJECT NO: 23.0319

# WARNER PARK COMMUNITY RECREATION CENTER EXPANSION

223471.00

6/13/2024

1625 NORTHPORT DRIVE MADISON, WI 53704 CITY OF MADISON PARKS DIVISION 330 EAST LAKESIDE STREET MADISON, WI 53715

PROJECT NUMBER

1 Addendum #2

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ISSUED FOR:

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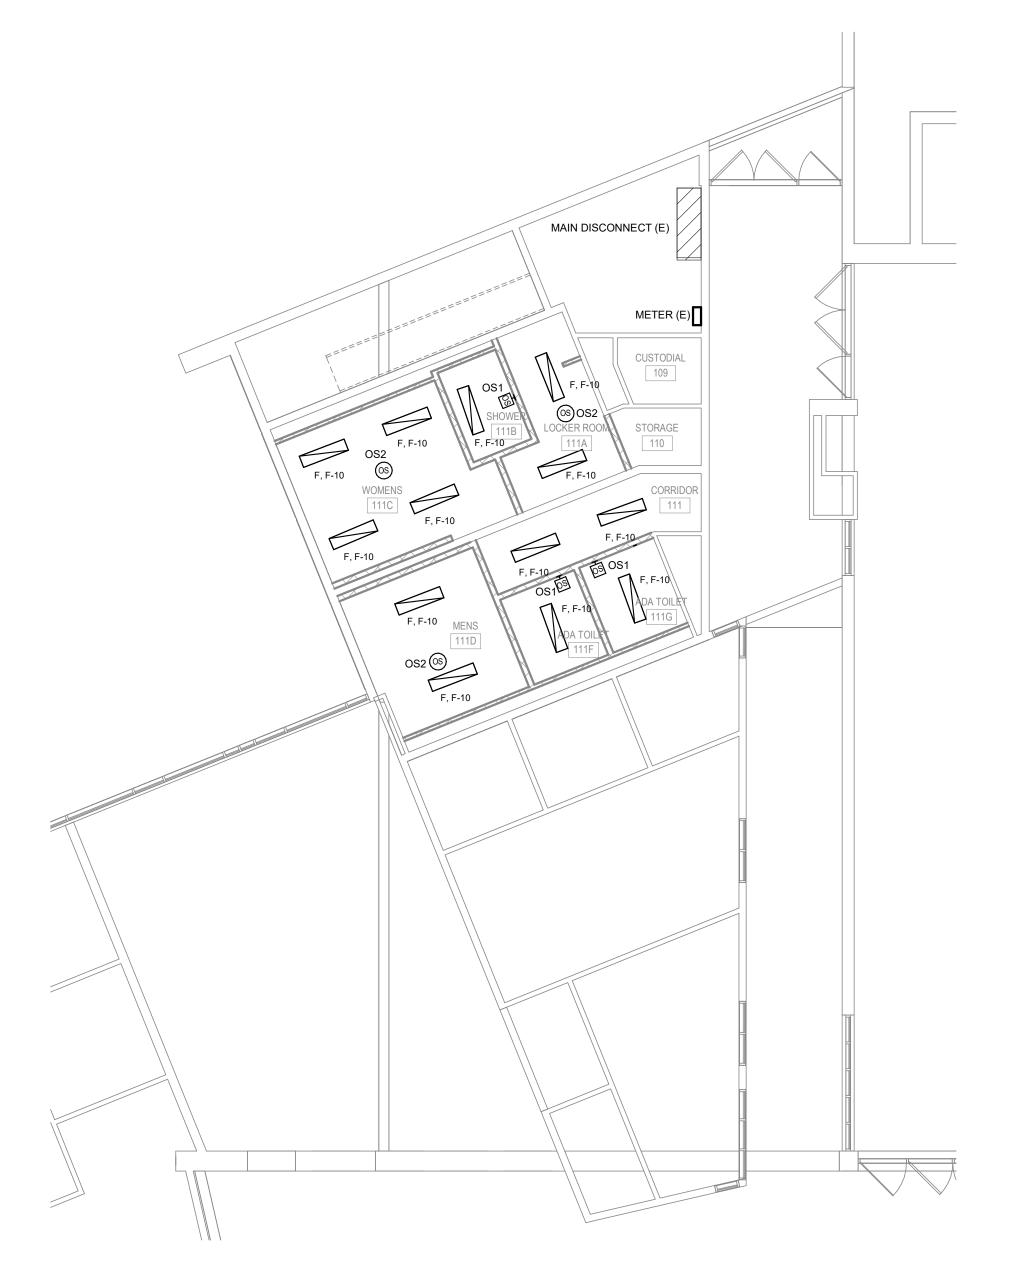
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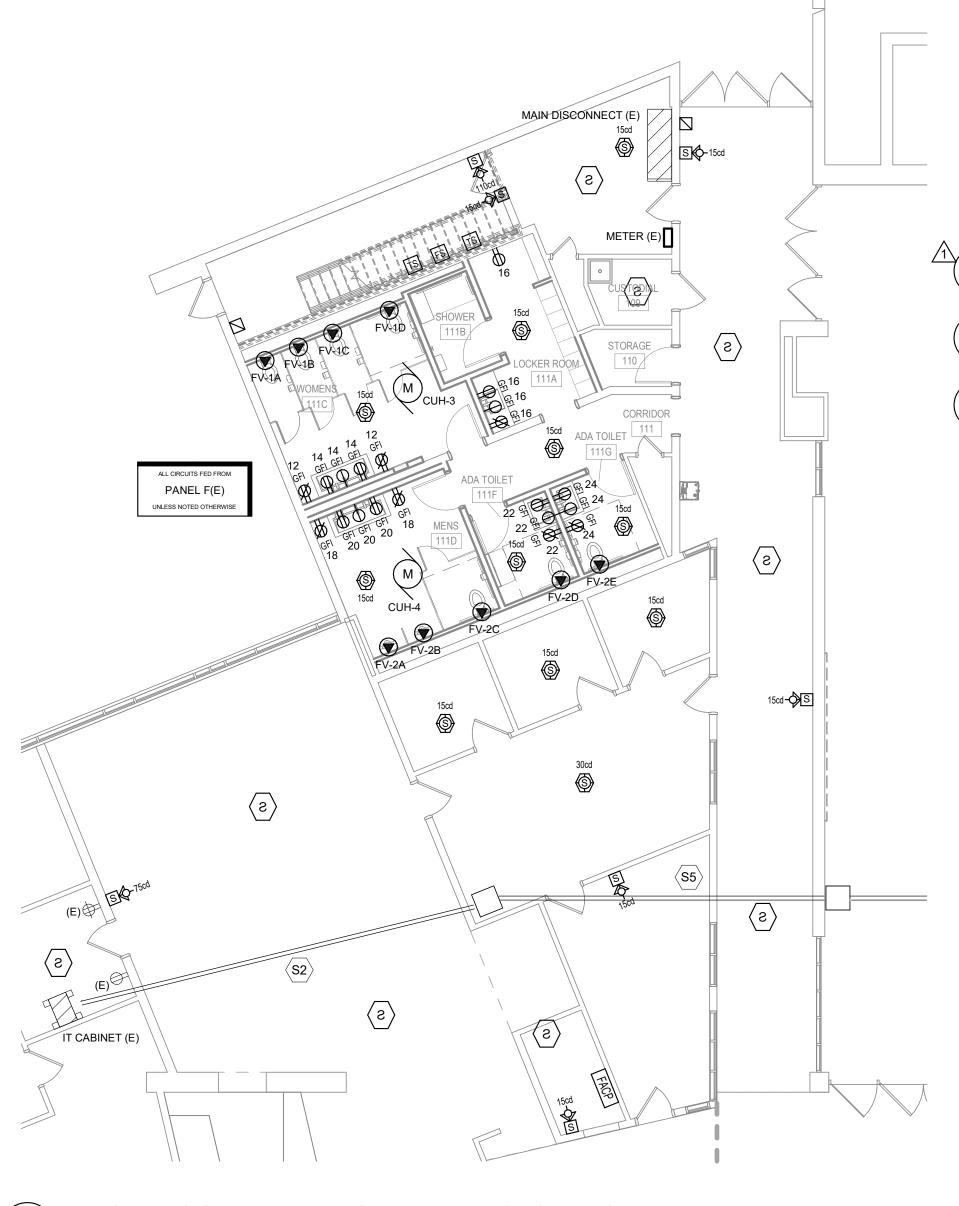
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CHECKED BY JDF

PARTIAL FIRST FLOOR PLAN – LIGHTING

PROJECT NORTH







1 FIRST FLOOR PLAN – POWER AND SYSTEMS
SCALE: 1/8" = 1'-0"

#### XA1, K-54 H, K-54, d H, K-54, d H, K-54, d H, K-54, d H, K-52, d H, K-54, d H, K-54, d E300 D, K-54 H, K-54, d H, K-54, d H, K-54, d H, K-54, d H, K-52, d H, K-52, d

3 CORRIDOR 105A - LIGHTING E300 SCALE: 1/4" = 1'-0"

## **LIGHTING CONTROLS GENERAL NOTES:**

- 1. REFER TO SHEET E000 FOR ALL SYMBOLS, ABBREVIATIONS, AND DETAILS.
- 2. OCCUPANCY SENSOR LOCATIONS SHOWN ARE DIAGRAMMATIC ONLY. ACTUAL LOCATION TO BE DETERMINED IN FIELD PER MANUFACTURER'S RECOMMENDATIONS AND LAYOUT. PROVIDE A MINIMUM 4'-0" OF FLEX CONDUIT/WIRING SO THAT THE SENSOR CAN BE FIELD ADJUSTED FOR PROPER COVERAGE DURING FINAL COMMISSIONING. THE TRAINED FACTORY PERSONNEL SHALL PERFORM THE FINAL COMMISSIONING.

#### **POWER GENERAL NOTES:**

- 1. REFER TO SHEET E000 FOR ALL SYMBOLS, ABBREVIATIONS, AND DETAILS.
- THE CONTRACTOR MAY INSTALL UP TO THREE (3) CURRENT CARRYING CONDUCTORS IN A CONDUIT. LOADINGS ARE BASED ON THWN INSULATION, 40°C AMBIENT WITH DERATINGS FOR TEMPERATURE AND UP TO THREE (3) CONDUCTORS IN A CONDUIT. CONTACT THE ENGINEER FOR WIRING IN OTHER CONDITIONS.
- VERIEX ALL MOUNTING HEIGHTS OF DEVICES ABOVE MILLWORK WITH ARCHITECTURAL PLANS.
- NOTE THAT THIS PROJECT CONSISTS OF A COMPLETE REPLACEMENT OF THE FIRE ALARM SYSTEM AS SHOWN ON THE PLANS. ANY/ALL EXISTING FIRE ALARM DEVICES, CONTROL PANELS, ANNUNCIATOR PANELS, CABLING, ETC. SHALL BE DISCONNECTED AND REMOVED COMPLETE. REUSE OF EXISTING INFRASTRUCTURE (BOXES AND CONDUITS ONLY) IS ACCEPTABLE WHERE SIZED AND SUPPORTED PROPERLY. THE NEW VOICE FIRE ALARM SYSTEM THROUGHOUT THE BUILDING SHALL BE INSTALLED, PROGRAMMED, TESTED, COMMISSIONED, AND APPROVED BY THE LOCAL AHJ PRIOR TO DECOMMISSIONING AND REMOVING THE EXISTING FIRE ALARM SYSTEM. ANY/ALL NEW FIRE ALARM DEVICES SHALL BE RECESSED IN EXISTING WALLS/CEILINGS UNLESS INDICATED OTHERWISE. ANY AND ALL FIRE ALARM CABLING SHALL BE EMT CONDUIT AT A MINIMUM. NO FREE AIR CABLING IS ALLOWED. ANY/ALL EXISTING BOXES AND CONDUITS WITHIN THE EXISTING BUILDING THAT ARE REMOVED SHALL HAVE THE EXISTING WALLS/CEILINGS PATCHED AND PAINTED TO OWNER'S SATISFACTION.
- ALL RECEPTACLES WITH PLUGLOAD CONTROL SHALL BE CONTROLLABLE VIA THE LIGHTING CONTROLS SHOWN ON THE LIGHTING PLANS. PROVIDE CONTROL DEVICES, ETC. AS REQUIRED TO ACHIEVE THE CONTROLS SHOWN.

#### **SYSTEMS GENERAL NOTES:**

- 1. ALL LOW VOLTAGE CABLES OR CONDUCTORS OPERATING AT LESS THAN 50 VOLTS SHALL BE IN ELECTRICAL METAL TUBING (EMT) WHERE INSTALLED WITHIN WALLS OR INACCESSIBLE SPACES.
- 2. TV OUTLETS, VOLUME CONTROLS, TELEPHONE OUTLETS, AND DATA OUTLETS SHALL CONSIST OF A BACK BOX WITH CONDUIT STUBBED ABOVE THE ACCESSIBLE CEILING, SEE ROUGH-IN DETAIL. VERIFY SIZE OF BACK BOX REQUIRED WITH DEVICE TO BE INSTALLED. LOCATE BACK BOXES 6" FROM ADJACENT POWER RECEPTACLE INTENDED FOR COMPUTER USE.
- 3. ANY/ALL LOW VOLTAGE SYSTEMS, INCLUDING BUT NOT LIMITED TO THE FOLLOWING: COMMUNICATIONS, PAGING, CLOCK SYSTEM, CLASS BELLS, ETC., SHALL BE MAINTAINED THROUGHOUT CONSTRUCTION. FIELD VERIFY ALL LOW VOLTAGE SYSTEM REQUIREMENTS AND EXTEND/MAINTAIN/REUSE AS REQUIRED. EXTEND ANY/ALL NEW COMMUNICATIONS CABLING TO EXISTING MDF/IDF AS REQUIRED. COORDINATE JACK/CABLING REQUIREMENTS AND COLORS WITH OWNER.
- 4. CAMERA MOUNTING SHALL BE COORDINATED WITH OWNER. VERIFY DESIRED MOUNTING HEIGHT AND CAMERA MOUNT TYPE PRIOR TO INSTALL.
- 5. ALL WAP LOCATIONS SHOWN ARE APPROXIMATE. CONFIRM ALL EXACT/FINAL WAP LOCATIONS WITH CITY I.T. DEPARTMENT PRIOR TO ROUGH IN. WAP MOUNTING SHALL BE COORDINATED WITH OWNER. VERIFY DESIRED MOUNTING HEIGHT AND WAP MOUNT TYPE PRIOR TO INSTALL.
- 6. ALL NEW CAT6 CABLING SHALL BE ROUTED TO STORAGE (TR ROOM) #105E.


# KEYED NOTES (KEYED NOTES PER PROJECT)

# L5 ELECTRICAL CONTRACTOR TO PROVIDE INTEGRAL BACKLIGHTING BEHIND PERFORATED ARCHITECTURAL CEILING PANELS

- THROUGHOUT CORRIDOR 105A FIELD CUT BACKLIGHTING SECTIONS
  THAT DO NOT FIT IN 2'X4' LIGHT TRAYS.

  L7 ELECTRICAL CONTRACTOR TO PROVIDE INTEGRAL BACKLIGHTING
  BEHIND PERFORATED ARCHITECTURAL CEILING PANELS IN
- VERTICAL SECTION IN PRE-FUNCTION 105C. FIELD CUT
  BACKLIGHTING SECTIONS THAT DO NOT FIT IN 2'X4' LIGHT TRAYS.

  S2 FOR CONNECTION OF TELECOM ROOMS, BUN TWELVE STRAND
  SINGLE MODE FIBER FROM STORAGE (TR ROOM) 123 TO STORAGE
  (TR ROOM) 105E. TERMINATE WITH LC CONNECTORS ON CABINET
  MOUNTED PATCH PANEL IN EACH TR. PROVIDE 12 LC TO LC PATCH
- S5 PROVIDE AND INSTALL (2) 2" CONDUITS ROUTED FROM STORAGE (TR ROOM) 123 TO STORAGE (TR ROOM) 105E. PROVIDE JUNCTION BOXES ABOVE CEILING IN WORK ROOM 115 AND IN GYMNASIUM 105 APPROXIMATELY AS SHOWN. CONDUITS SHALL BE PAINTED TO MATCH EXISTING CEILING/UTILITIES COLOR WHEN ROUTED THROUGH SPACE(S) WITH NO CEILINGS.

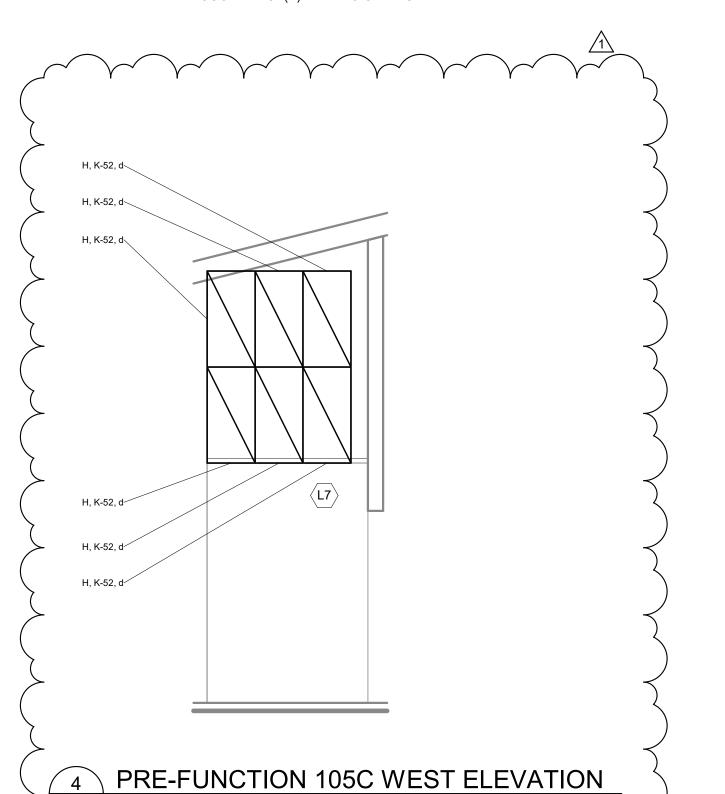



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ENGINEERING, INC 5525 NOBEL DRIVE

SUITE 110 MADISON, WI 53711 PH: 608.277.1728 FAX: 608.271.7046 JDR PROJECT NO: 23.0319

# WARNER PARK COMMUNITY RECREATION CENTER EXPANSION

223471.00

1625 NORTHPORT DRIVE MADISON, WI 53704 CITY OF MADISON PARKS DIVISION 330 EAST LAKESIDE STREET MADISON, WI 53715

PROJECT NUMBER

ISSUED FOR:

BID SET 5/16/2024

REVISION FOR:

NO. DESCRIPTION DATE

1 Addendum #2 6/13/2024


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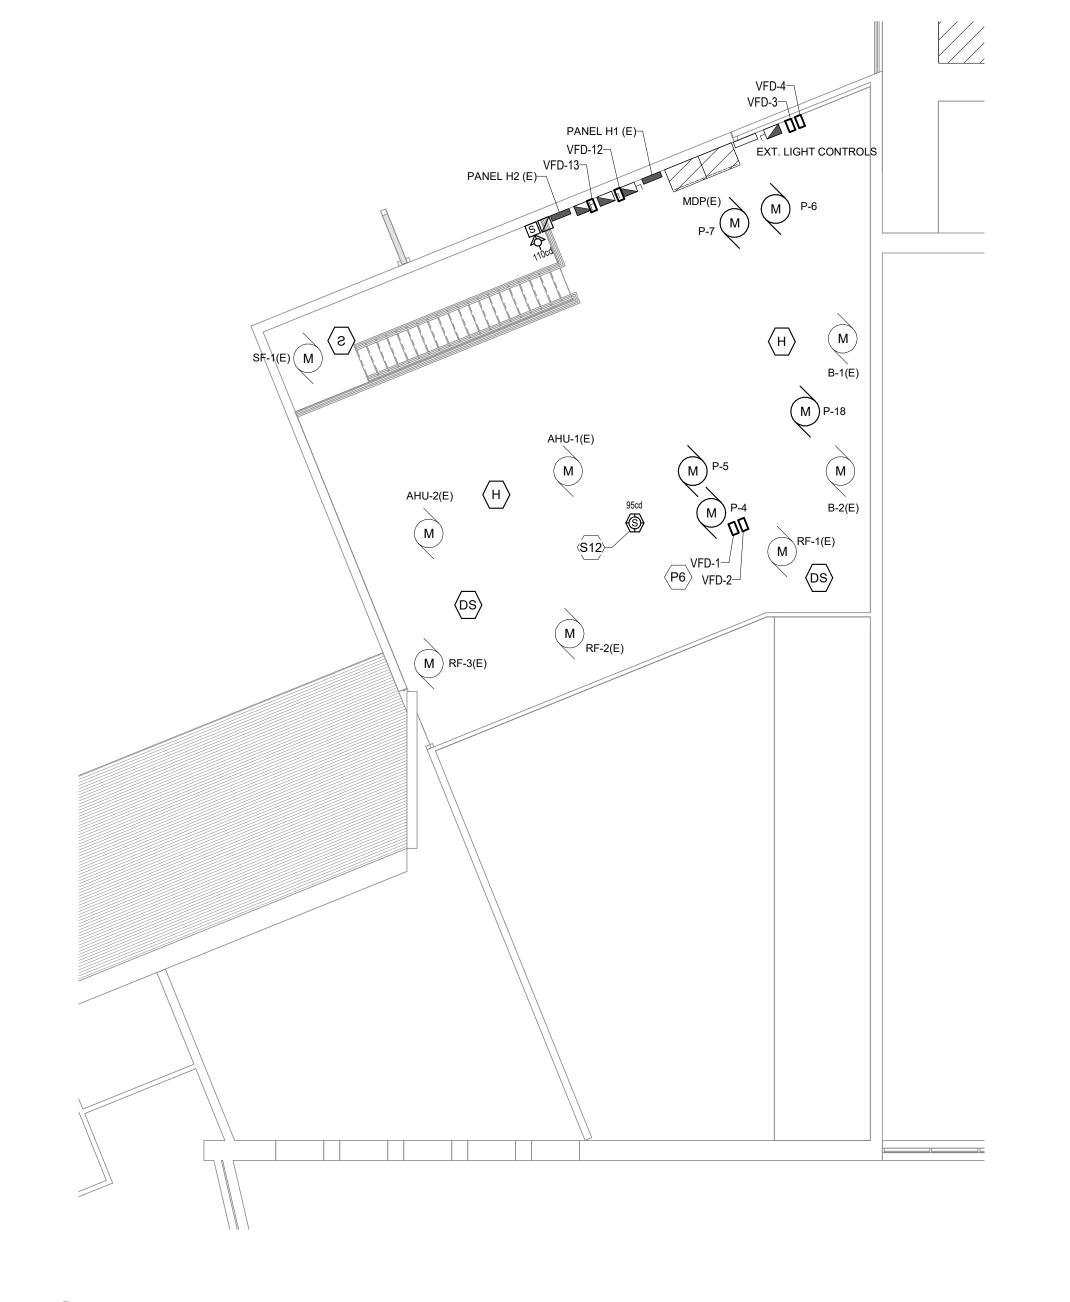
JDR

LARGE SCALE PLANS - ELECTRICAL

CHECKED BY

E300



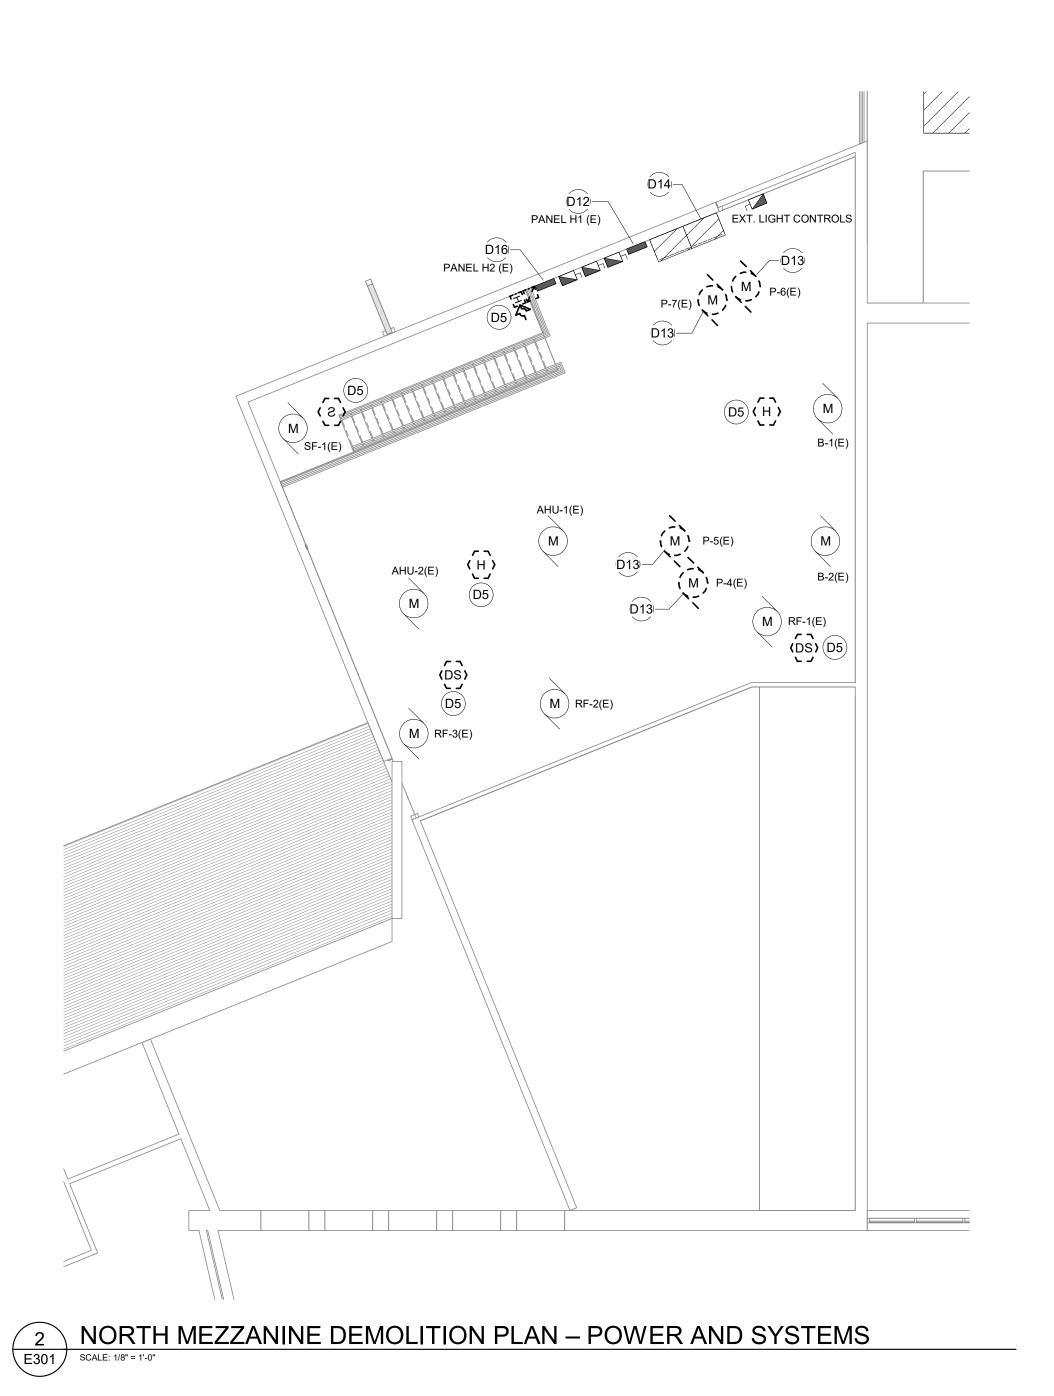

1 NORTH MEZZANINE PLAN – POWER AND SYSTEMS
SCALE: 1/8" = 1'-0"

## **SYSTEMS GENERAL NOTES:**

- 1. ALL LOW VOLTAGE CABLES OR CONDUCTORS OPERATING AT LESS THAN 50 VOLTS SHALL BE IN ELECTRICAL METAL TUBING (EMT) WHERE INSTALLED WITHIN WALLS OR INACCESSIBLE SPACES.
- 2. TV OUTLETS, VOLUME CONTROLS, TELEPHONE OUTLETS, AND DATA OUTLETS SHALL CONSIST OF A BACK BOX WITH CONDUIT STUBBED ABOVE THE ACCESSIBLE CEILING, SEE ROUGH-IN DETAIL. VERIFY SIZE OF BACK BOX REQUIRED WITH DEVICE TO BE INSTALLED. LOCATE BACK BOXES 6" FROM ADJACENT POWER RECEPTACLE INTENDED FOR COMPUTER USE.
- 3. ANY/ALL LOW VOLTAGE SYSTEMS, INCLUDING BUT NOT LIMITED TO THE FOLLOWING: COMMUNICATIONS, PAGING, CLOCK SYSTEM, CLASS BELLS, ETC., SHALL BE MAINTAINED THROUGHOUT CONSTRUCTION. FIELD VERIFY ALL LOW VOLTAGE SYSTEM REQUIREMENTS AND EXTEND/MAINTAIN/REUSE AS REQUIRED. EXTEND ANY/ALL NEW COMMUNICATIONS CABLING TO EXISTING MDF/IDF AS REQUIRED. COORDINATE JACK/CABLING REQUIREMENTS AND COLORS WITH OWNER.
- 4. CAMERA MOUNTING SHALL BE COORDINATED WITH OWNER. VERIFY DESIRED MOUNTING HEIGHT AND CAMERA MOUNT TYPE PRIOR TO INSTALL.
- 5. ALL WAP LOCATIONS SHOWN ARE APPROXIMATE. CONFIRM ALL EXACT/FINAL WAP LOCATIONS WITH CITY I.T. DEPARTMENT PRIOR TO ROUGH IN. WAP MOUNTING SHALL BE COORDINATED WITH OWNER. VERIFY DESIRED MOUNTING HEIGHT AND WAP MOUNT TYPE PRIOR TO INSTALL.
- 6. ALL NEW CAT6 CABLING SHALL BE ROUTED TO STORAGE (TR ROOM) #105E.

# POWER GENERAL NOTES:

- 1. REFER TO SHEET E000 FOR ALL SYMBOLS, ABBREVIATIONS, AND DETAILS.
- 2. THE CONTRACTOR MAY INSTALL UP TO THREE (3) CURRENT CARRYING CONDUCTORS IN A CONDUIT. LOADINGS ARE BASED ON THWN INSULATION, 40°C AMBIENT WITH DERATINGS FOR TEMPERATURE AND UP TO THREE (3) CONDUCTORS IN A CONDUIT. CONTACT THE ENGINEER FOR WIRING IN OTHER CONDITIONS.

3. VERIFY ALL MOUNTING HEIGHTS OF DEVICES ABOVE MILLWORK WITH ARCHITECTURAL PLANS. NOTE THAT THIS PROJECT CONSISTS OF A COMPLETE REPLACEMENT OF THE FIRE ALARM SYSTEM AS SHOWN ON THE PLANS. ANY/ALL EXISTING FIRE ALARM DEVICES, CONTROL PANELS, ANNUNCIATOR PANELS, CABLING, ETC. SHALL BE DISCONNECTED AND REMOVED COMPLETE. REUSE OF EXISTING INFRASTRUCTURE (BOXES AND CONDUITS ONLY) IS ACCEPTABLE WHERE SIZED AND SUPPORTED PROPERLY. THE NEW VOICE FIRE ALARM SYSTEM THROUGHOUT THE BUILDING SHALL BE INSTALLED, PROGRAMMED, TESTED, COMMISSIONED, AND APPROVED BY THE LOCAL AHJ PRIOR TO DECOMMISSIONING AND REMOVING THE EXISTING FIRE ALARM SYSTEM. ANY/ALL NEW FIRE ALARM DEVICES SHALL BE RECESSED IN EXISTING WALLS/CEILINGS UNLESS INDICATED OTHERWISE. ANY AND ALL FIRE ALARM CABLING SHALL BE EMT CONDUIT AT A MINIMUM. NO FREE AIR CABLING IS ALLOWED. ANY/ALL EXISTING BOXES AND CONDUITS WITHIN THE EXISTING BUILDING THAT ARE REMOVED SHALL HAVE THE EXISTING WALLS/CEILINGS PATCHED AND PAINTED TO OWNER'S SATISFACTION. ANY/ALL NEW BOXES AND CONDUITS WITHIN THE EXISTING BUILDING THAT ARE SURFACE MOUNTED ON EXISTING WALLS/CEILINGS SHALL BE PAINTED TO OWNER'S SATISFACTION. ALL RECEPTACLES WITH PLUGLOAD CONTROL SHALL BE CONTROLLABLE VIA THE LIGHTING CONTROLS SHOWN ON THE LIGHTING PLANS. PROVIDE CONTROL DEVICES, ETC. AS REQUIRED TO ACHIEVE THE CONTROLS SHOWN.

## DEMOLITION KEYED NOTES

- (KEYED NOTES PER PROJECT)

  D5 EXISTING FIRE ALARM INITIATION DEVICE TO BE DISCONNECTED,
- REMOVED, AND REPLACED. CONNECT TO NEW FIRE ALARM CONTROL PANEL IN SAME LOCATION.
- D12 EXISTING CUTLER HAMMER PRL1A 225A 120/208V 3PH PANEL 'H1' TO REMAIN.
- D13 EXISTING PUMP TO BE DISCONNECTED AND REMOVED BY OTHERS. REMOVE FEEDER BACK TO SOURCE. DISCONNECT AND REMOVE EXISTING BREAKER AND REPLACE WITH NEW BREAKER SIZE SHOWN ON E800.
- D14 CHALLENGER 1600A 208Y/120V SWITCHBOARD EXISTING TO REMAIN. REFER TO E600 FOR DETAILS.
- D16 EXISTING CUTLER HAMMER PRL1A 225A 120/208V 3PH PANEL 'H2' TO

Engberg Andersor ARCHITEC

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JDR ENGINEERING, INC.

5525 NOBEL DRIVE SUITE 110 MADISON, WI 53711 PH: 608.277.1728 FAX: 608.271.7046 JDR PROJECT NO: 23.0319

# WARNER PARK COMMUNITY RECREATION CENTER EXPANSION

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MADISON, WI 53715

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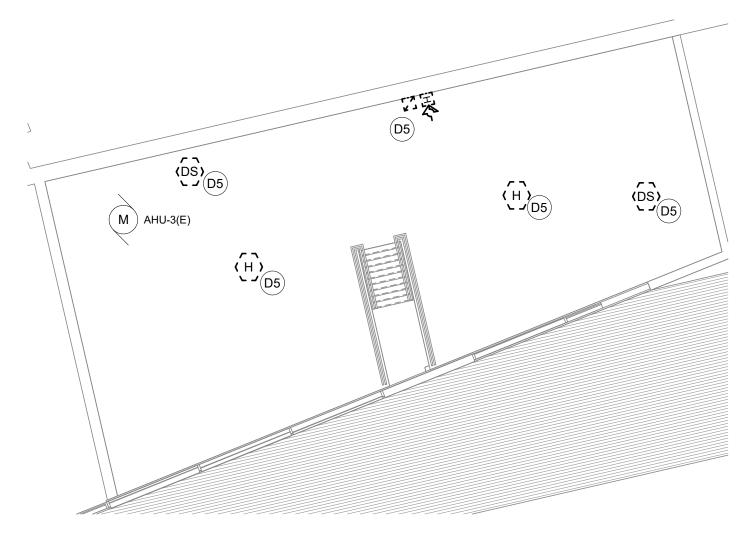
NO. DESCRIPTION DATE

1 Addendum #2 6/13/2024


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CHECKED BY JDR

LARGE SCALE PLANS -NORTH MEZZANINE





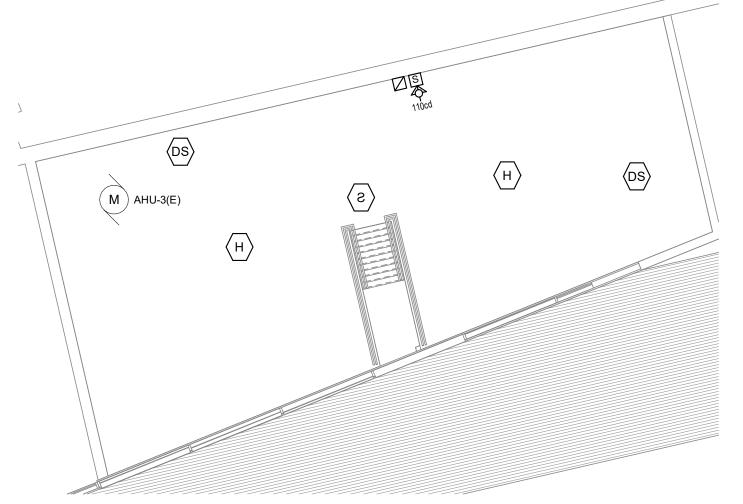

1 SOUTH MEZZANINE PLAN – POWER AND SYSTEMS

# SYSTEMS GENERAL NOTES:

- 1. ALL LOW VOLTAGE CABLES OR CONDUCTORS OPERATING AT LESS THAN 50 VOLTS SHALL BE IN ELECTRICAL METAL TUBING (EMT) WHERE INSTALLED WITHIN WALLS OR INACCESSIBLE SPACES.
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# POWER GENERAL NOTES:

- 1. REFER TO SHEET E000 FOR ALL SYMBOLS, ABBREVIATIONS, AND DETAILS.
- 2. THE CONTRACTOR MAY INSTALL UP TO THREE (3) CURRENT CARRYING CONDUCTORS IN A CONDUIT. LOADINGS ARE BASED ON THWN INSULATION, 40°C AMBIENT WITH DERATINGS FOR TEMPERATURE AND UP TO THREE (3) CONDUCTORS IN A CONDUIT. CONTACT THE ENGINEER FOR WIRING IN OTHER CONDITIONS.

# VERIFYALL MOUNTING HEIGHTS OF DEVICES ABOVE MILLWORK WITH ARCHITECTURAL PLANS

- 4. NOTE THAT THIS PROJECT CONSISTS OF A COMPLETE REPLACEMENT OF THE FIRE ALARM SYSTEM AS SHOWN ON THE PLANS. ANY/ALL EXISTING FIRE ALARM DEVICES, CONTROL PANELS, ANNUNCIATOR PANELS, CABLING, ETC. SHALL BE DISCONNECTED AND REMOVED COMPLETE. REUSE OF EXISTING INFRASTRUCTURE (BOXES AND CONDUITS ONLY) IS ACCEPTABLE WHERE SIZED AND SUPPORTED PROPERLY. THE NEW VOICE FIRE ALARM SYSTEM THROUGHOUT THE BUILDING SHALL BE INSTALLED, PROGRAMMED, TESTED, COMMISSIONED, AND APPROVED BY THE LOCAL AHJ PRIOR TO DECOMMISSIONING AND REMOVING THE EXISTING FIRE ALARM SYSTEM. ANY/ALL NEW FIRE ALARM DEVICES SHALL BE RECESSED IN EXISTING WALLS/CEILINGS UNLESS INDICATED OTHERWISE. ANY AND ALL FIRE ALARM CABLING SHALL BE EMT CONDUIT AT A MINIMUM. NO FREE AIR CABLING IS ALLOWED. ANY/ALL EXISTING BOXES AND CONDUITS WITHIN THE EXISTING BUILDING THAT ARE REMOVED SHALL HAVE THE EXISTING WALLS/CEILINGS PATCHED AND PAINTED TO OWNER'S SATISFACTION. ANY/ALL NEW BOXES AND CONDUITS WITHIN THE EXISTING BUILDING THAT ARE SURFACE MOUNTED ON EXISTING WALLS/CEILINGS SHALL BE PAINTED TO OWNER'S SATISFACTION.
- ALL RECEPTACLES WITH PLUGLOAD CONTROL SHALL BE CONTROLLABLE VIA THE LIGHTING CONTROLS SHOWN ON THE LIGHTING PLANS. PROVIDE CONTROL DEVICES, ETC. AS REQUIRED TO ACHIEVE THE CONTROLS SHOWN.

## DEMOLITION KEYED NOTES

(KEYED NOTES PER PROJECT)

D5 EXISTING FIRE ALARM INITIATION DEVICE TO BE DISCONNECTED, REMOVED, AND REPLACED. CONNECT TO NEW FIRE ALARM CONTROL PANEL IN SAME LOCATION.



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MADISON, WI 53711

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# WARNER PARK COMMUNITY RECREATION CENTER EXPANSION

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223471.00


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BID SI	ET	5/16/2024
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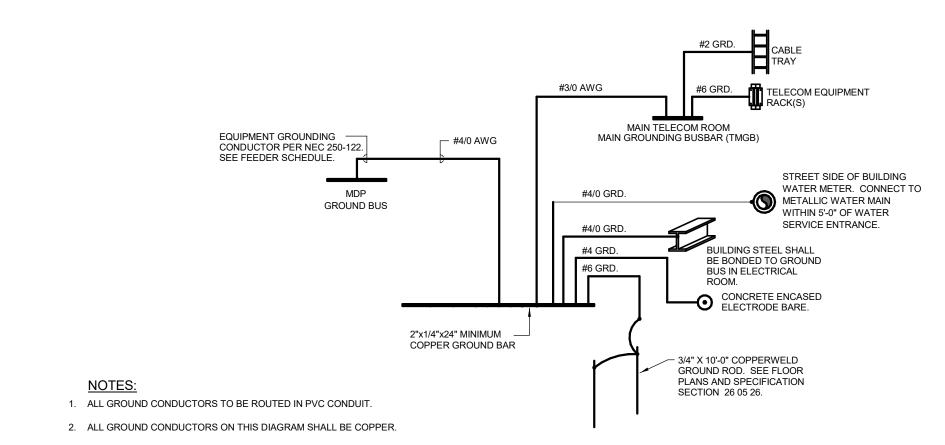
DRAWN BY JDR

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LARGE SCALE PLANS -SOUTH MEZZANINE


E302




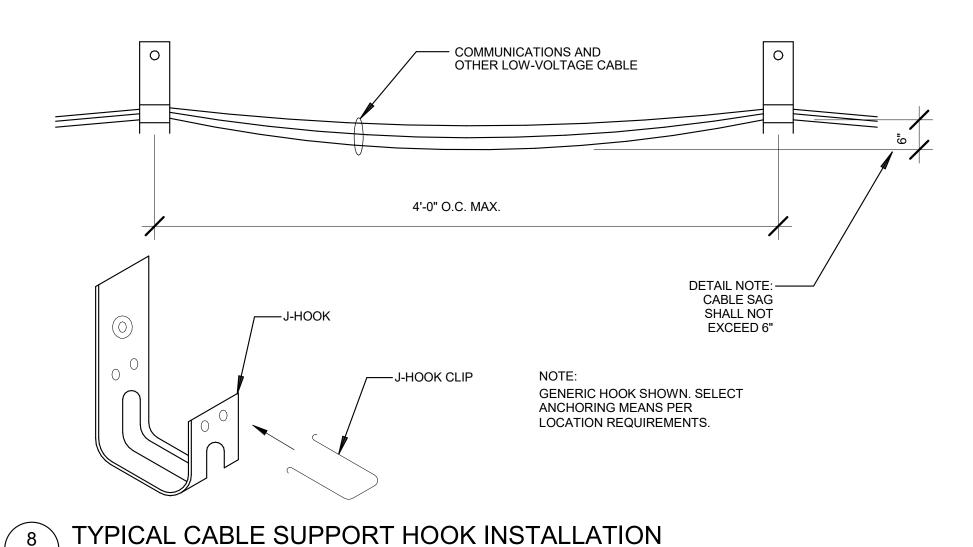

TYPICAL GROUNDING SYSTEM E900 SCALE: NONE


E900 SCALE: NONE

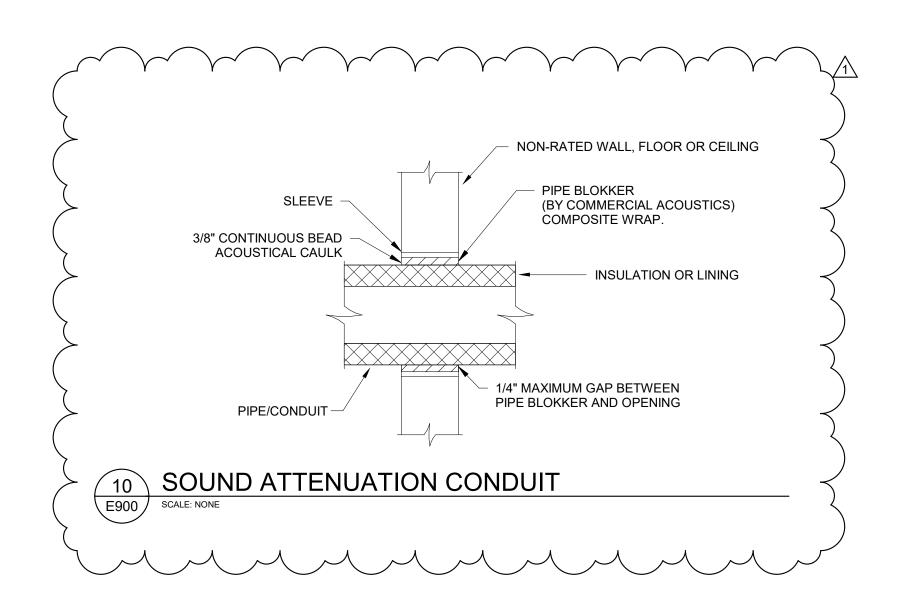

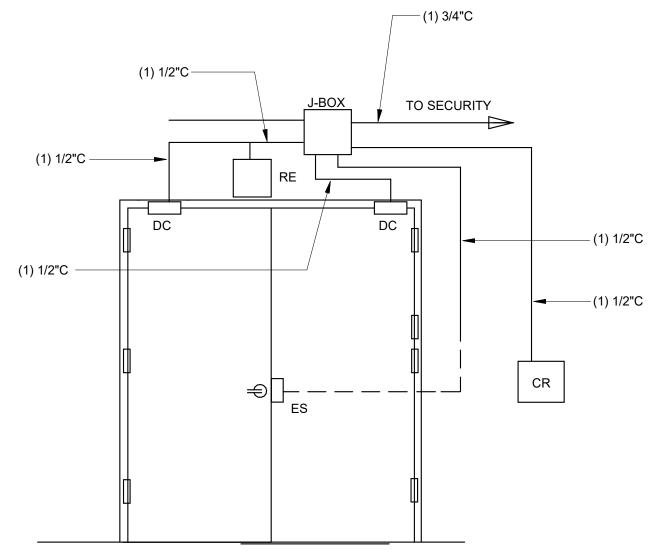


- CARD READER CONTROL WITH ELECTRIC STRIKE.
- ENTRY BY CARD READER. EXIT IS MANUAL AND ALWAYS AVAILABLE.
- REQUEST TO EXIT SHOWN ON PLANS.
- NOT ALL DEVICES ON DETAIL ARE AT EACH DOOR. REFER TO PLAN.

#### TYPICAL ACCESS CONTROLS DOUBLE DOORS SCALE: NONE ∖E900 /

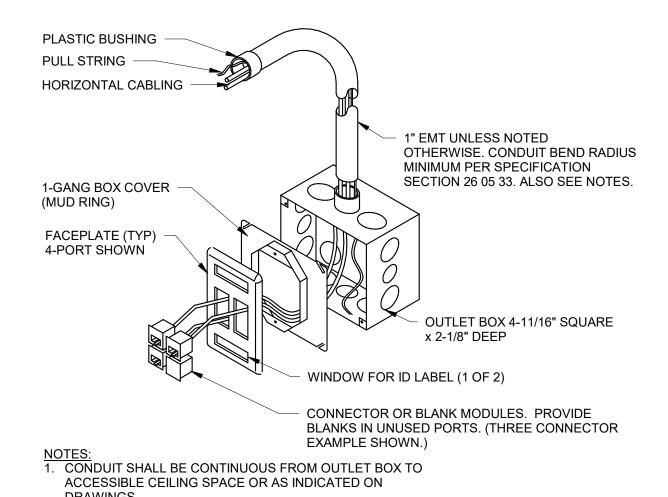


- 2. PROVIDE PULL STRING IN ALL CONDUITS.
- 3. REFER TO SPECIFICATION SECTION 27 00 05 FOR
- CONNECTOR TYPES.

## TYPICAL COMMUNICATION EQUIPMENT OUTLET E900 SCALE: NONE

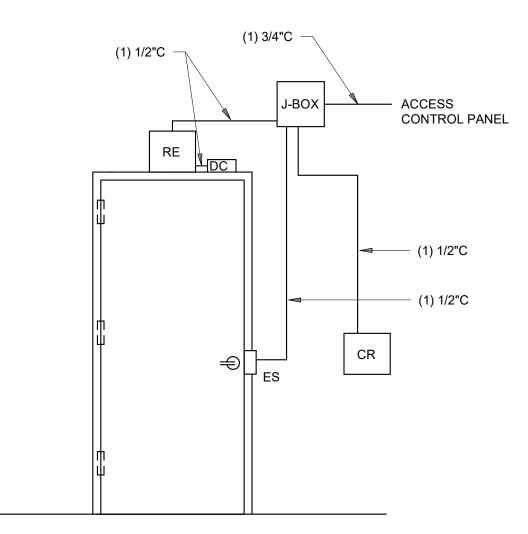


- CARD READER CONTROL WITH ELECTRIC STRIKE.
- ENTRY BY CARD READER. EXIT IS MANUAL AND ALWAYS AVAILABLE.
- REQUEST TO EXIT SHOWN ON PLANS.
- NOT ALL DEVICES ON DETAIL ARE AT EACH DOOR. REFER TO PLAN.

7 TYPICAL ACCESS CONTROLS SINGLE DOOR E900 SCALE: NONE

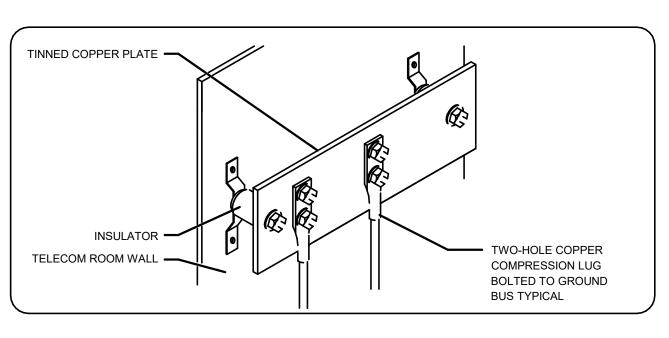



AXONOMETRIC VIEW

## TYPICAL GROUNDING BAR E900 SCALE: NONE

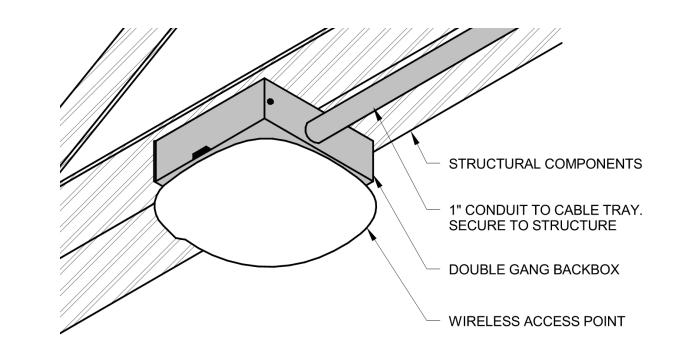


2 TYPICAL WIRELESS ACCESS POINT PENDANT MOUNT E900 SCALE: NONE

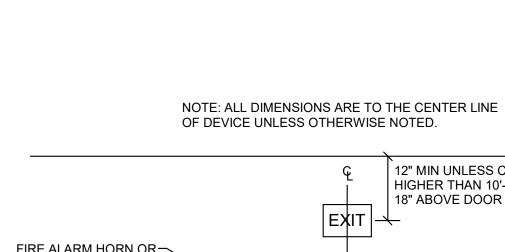

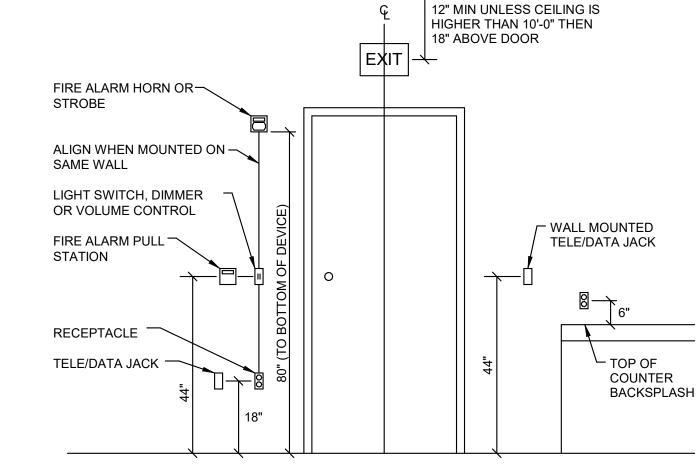

TYPICAL MOUNTING HEIGHTS E900 SCALE: NONE

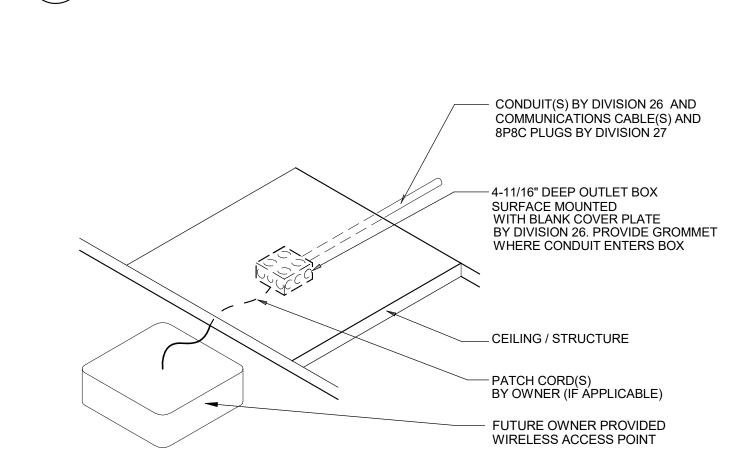

TYPICAL EQUIPMENT OUTLET FOR WIRELESS ACCESS - SURFACE E900 SCALE: NONE



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# WARNER PARK COMMUNITY RECREATION **CENTER EXPANSION**

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DRAWN BY

JDR

**DETAILS - ELECTRICAL** 

CHECKED BY

E900